

### LEGAL DESCRIPTION:

A part of the NW1/4 of the SE1/4 of Section 2, T17N, R31W in Washington County, Arkansas, and being described as follows: Commencing at the NW Corner of said NW1/4, SE1/4, thence S86°16'56"E 665.00 feet, thence S03°28'24"W 381.65 feet to the POINT OF BEGINNING, thence S87°01'12"E 160.01 feet, thence S03°29'36"W 435.76 feet, thence N87°01'12"W 98.99 feet, thence along a non tangent curve to the left 95.49 feet, said curve having a radius of 61.00 feet and chord bearing and distance of N41°39'31"W 86.03 feet, thence N03°29'24"E 374.54 feet to the POINT OF BEGINNING: Containing 1.53 acres more or less subject to easements and right of way of record.

8937 HOBBTOWN RD RUDY, AR 72952

1) ZONING: C-2

PARCEL NUMBERS: 830-37719-003

THIS PROPERTY IS NOT AFFECTED BY THE 100 YEAR FLOOD PLAIN AS PER FIRM #05143C0045F DATED MAY 16,

Certificate of Preliminary Survey Accuracy. I, David L. Jorgensen, hereby certify that this plat correctly represents a boundary survey made by me and all monuments shown hereon actually exist and their location, size, type and material are correctly shown.

Registered Land Surveyor

Date of Execution:

State of Arkansas Registration No. 1118

Certificate of Preliminary Engineering Accuracy. Each set of street and drainage plans must be submitted in accordance with applicable state statutes and any

I, Jared S. Inman, hereby certify that this plan correctly represents a plan prepared under my direction and engineering requirements of the Tontitown Subdivision Regulations have been complied with.

Date of Execution:

Registered Engineer

State of Arkansas Registration No. 13842


Certificate of Preliminary Plat Approval. This plat has been given preliminary plat approval only and has not been approved for recording purposes as a public record. This certificate shall expire on \_\_\_\_\_(date).

Date of Execution: \_\_\_\_

Chairman, City of Tontitown Planning Commission

## LARGE SCALE DEVELOPMENT

# **BURTON WAREHOUSE**

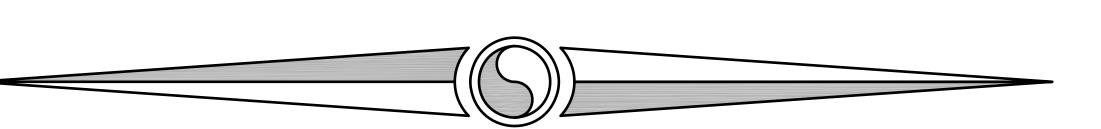

### **FEBRUARY 2017**

## **OWNER / DEVELOPER**

BCRD, LLC **8937 HOBBTOWN RD RUDY, AR 72952** 

CITY OF TONTITOWN:

235 E. Henri De Tonti Blvd. Ph: (479) 361-2700 Tontitown, AR 72770 Fax: (479) 421-8774 Building and Inspection Ph: (479) 263-9215 Planning Ph: (479) 361-2700 Public Works - Emergency/After Hours Ph: (479) 263-9213 Public Safety Ph: (479) 361-2700 Solid Waste Ph: (479) 361-2700 Water & Sewer Ph: (479) 361-2700 Ph: (479) 263-9216

### PREPARED BY:



5. CONTACT ALL UTILITIES PRIOR TO CONSTRUCTION TO INSURE THAT ALL EXISTING UTILITIES ARE LOCATED.

X THIS SITE DOES NOT CONTAIN MY KNOWN WETLANDS. AN ARMY CORPS OF ENGINEERS DETERMINATION IS NOT CURRENTLY IN PROGRESS AT THIS TIME.

X THERE ARE NO KNOWN PREVIOUS SANITARY SEWER OVERFLOW PROBLEMS ON-SITE OR IN THE PROXIMITY OF THE SITE.

X THERE ARE NO KNOWN POTENTIALLY DANGEROUS AREAS, SUCH AS AREAS SUBJECT TO FLOODING, SLOPE STABILITY, SETTLEMENT, EXCESSIVE NOISE, OR

X THIS SITE WILL NOT CONTAIN ANY PROPOSED PUBLIC AREAS. X THIS SITE WILL NOT CONTAIN ANY COMMONLY HELD AREAS.

> This Large Scale Development has been reviewed for general compliance with the City of Tontitown Zoning and Planning Ordinances. Oversight of any regulations does not relieve the Owner of their responsibility to comply with all regulations.

Terry W. Carpenter, P.E. Tontitown City Engineer, February 14, 2017



## INDEX OF SHEETS

C 0.00 COVER SHEET C 1.01 LARGE SCALE DEVELOPMENT C 1.02 GRADING & EROSION CONTROL PLAN C 1.03 PAVING PLAN L 1.00 LANDSCAPE PLAN C 5.01 DETAILS C 5.02 DETAILS



**I** ★ CALCULATED POINT FOUND RAILROAD SPIKE

 ○ SET IRON PIN & CAP POWER POLE

O™II FIRE HYDRANT

STREET LIGHT

PROPOSED 8" SEWER LINE EXISTING WATERLINE

PROPOSED 8" WATER L**I**NE CENTERLINE STREET BUILDING SETBACK

**UTILITY EASEMENT** NEW 5' SIDEWALK


EXISTING CONTOUR

FINISHED CONTOUR

PROJECT DETAILS

REVISIONS

PROJECT # 2016139 FILE PATH: Z:LSD\2016139\DWG SHEET SIZE: 22" x 34"

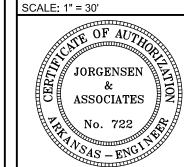


ARKANSAS
REGISTERED PROFESSIONAL **ENGINEER** \* \* \* No.13842

SHEET TITLE **COVER SHEET** 

SHEET NUMBER

C 0.00

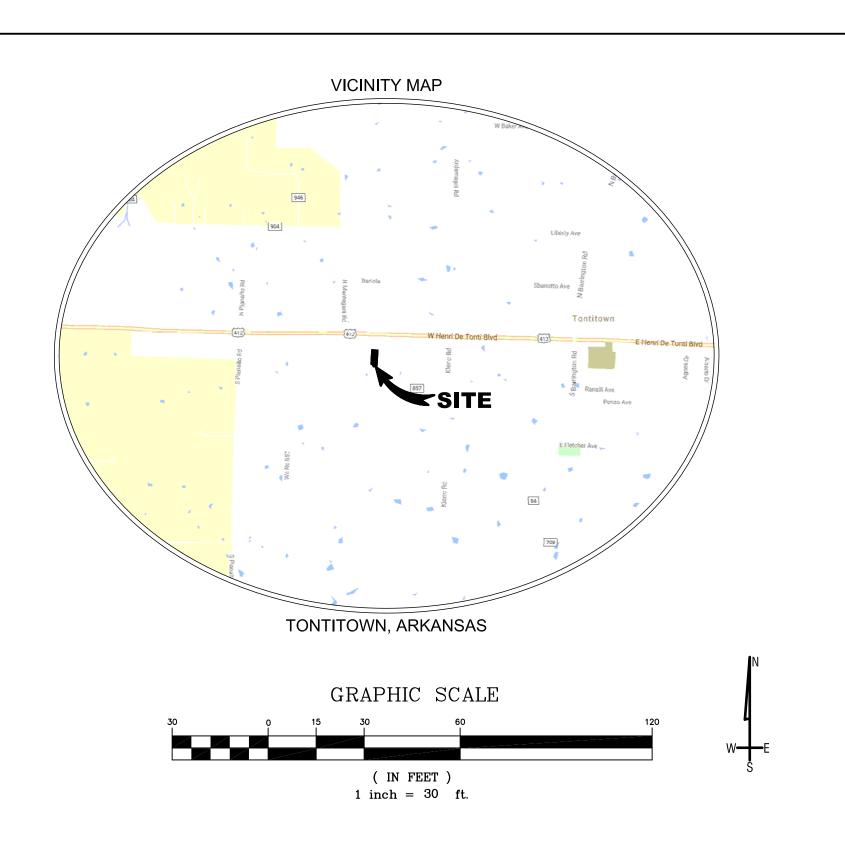

### LEGAL DESCRIPTION:

A part of the NW1/4 of the SE1/4 of Section 2, T17N, R31W in Washington County, Arkansas, and being described as follows: Commencing at the NW Corner of said NW1/4, SE1/4, thence S86°16'56"E 665.00 feet, thence S03°28'24"W 381.65 feet to the POINT OF BEGINNING, thence S87°01'12"E 160.01 feet, thence S03°29'36"W 435.76 feet, thence N87°01'12"W 98.99 feet, thence along a non tangent curve to the left 95.49 feet, said curve having a radius of 61.00 feet and chord bearing and distance of N41°39'31"W 86.03 feet, thence N03°29'24"E 374.54 feet to the POINT OF BEGINNING: Containing 1.53 acres more or less subject to easements and right of way of record.

<u>OWNER:</u> BCRD LLC

CONTACT: 8937 HOBBTOWN RD RUDY, AR 72952

NOTE

1) ZONING: C-2

2) PARCEL NUMBERS: 830-37719-003

3) THIS PROPERTY IS NOT AFFECTED BY THE 100 YEAR FLOOD PLAIN AS PER FIRM #05143C0045F DATED MAY 16, 2008.

SITE AREA CALCULATIONS:
TOTAL AREA: 1.533 AC / 66,799 S.F.

PREDEVELOPMENT:
-IMPERVIOUS: 0.00 AC / 0 S.F. (0.00%)
-PERVIOUS: 1.533 AC / 66,799 S.F. (100.00%)

POSTDEVELOPMENT:
-IMPERVIOUS: BUILDING: 25,675 S.F. (38.44%)
PARKING/SIDEWALK: 24,995 S.F. (37.42%)
TOTAL IMPERVIOUS: 1.163 AC / 50,670 S.F. (75.85%)
-PERVIOUS:GREENSPACE: 0.370 AC / 16,129 S.F. (24.15%)

C-2 BUILDING SETBACK	( TABLE
FRONT, WITH PARKING	50'
FRONT, WITHOUT PARKING	20'
SIDE, ADJACENT TO NON-RESIDENTIAL DISTRICT	1'
SIDE, ADJACENT TO RESIDENTIAL DISTRICT	30'
REAR, ADJACENT TO NON-RESIDENTIAL DISTRICT	20'
REAR, ADJACENT TO	201

RESIDENTIAL DISTRICT


PARKING REQUIREMENTS:


REQUIREMENT FOR RETAIL: 1 SPACE / 250 SQ. FT
REQUIRED: 2500 SQ. FT / 250 = 10 SPACES

REQUIREMENT FOR WAREHOUSE: 5 SPACES + 1 SPACE PER 2000 SQ. FT
REQUIRED: 5 + 23175 SQ. FT / 2000 = 17

TOTAL SPACES REQUIRED = 27
TOTAL SPACES PROVIDED = 27

REQUIRED ADA SPACES = 2 SPACES
PROVIDED ADA SPACES = 2 SPACES

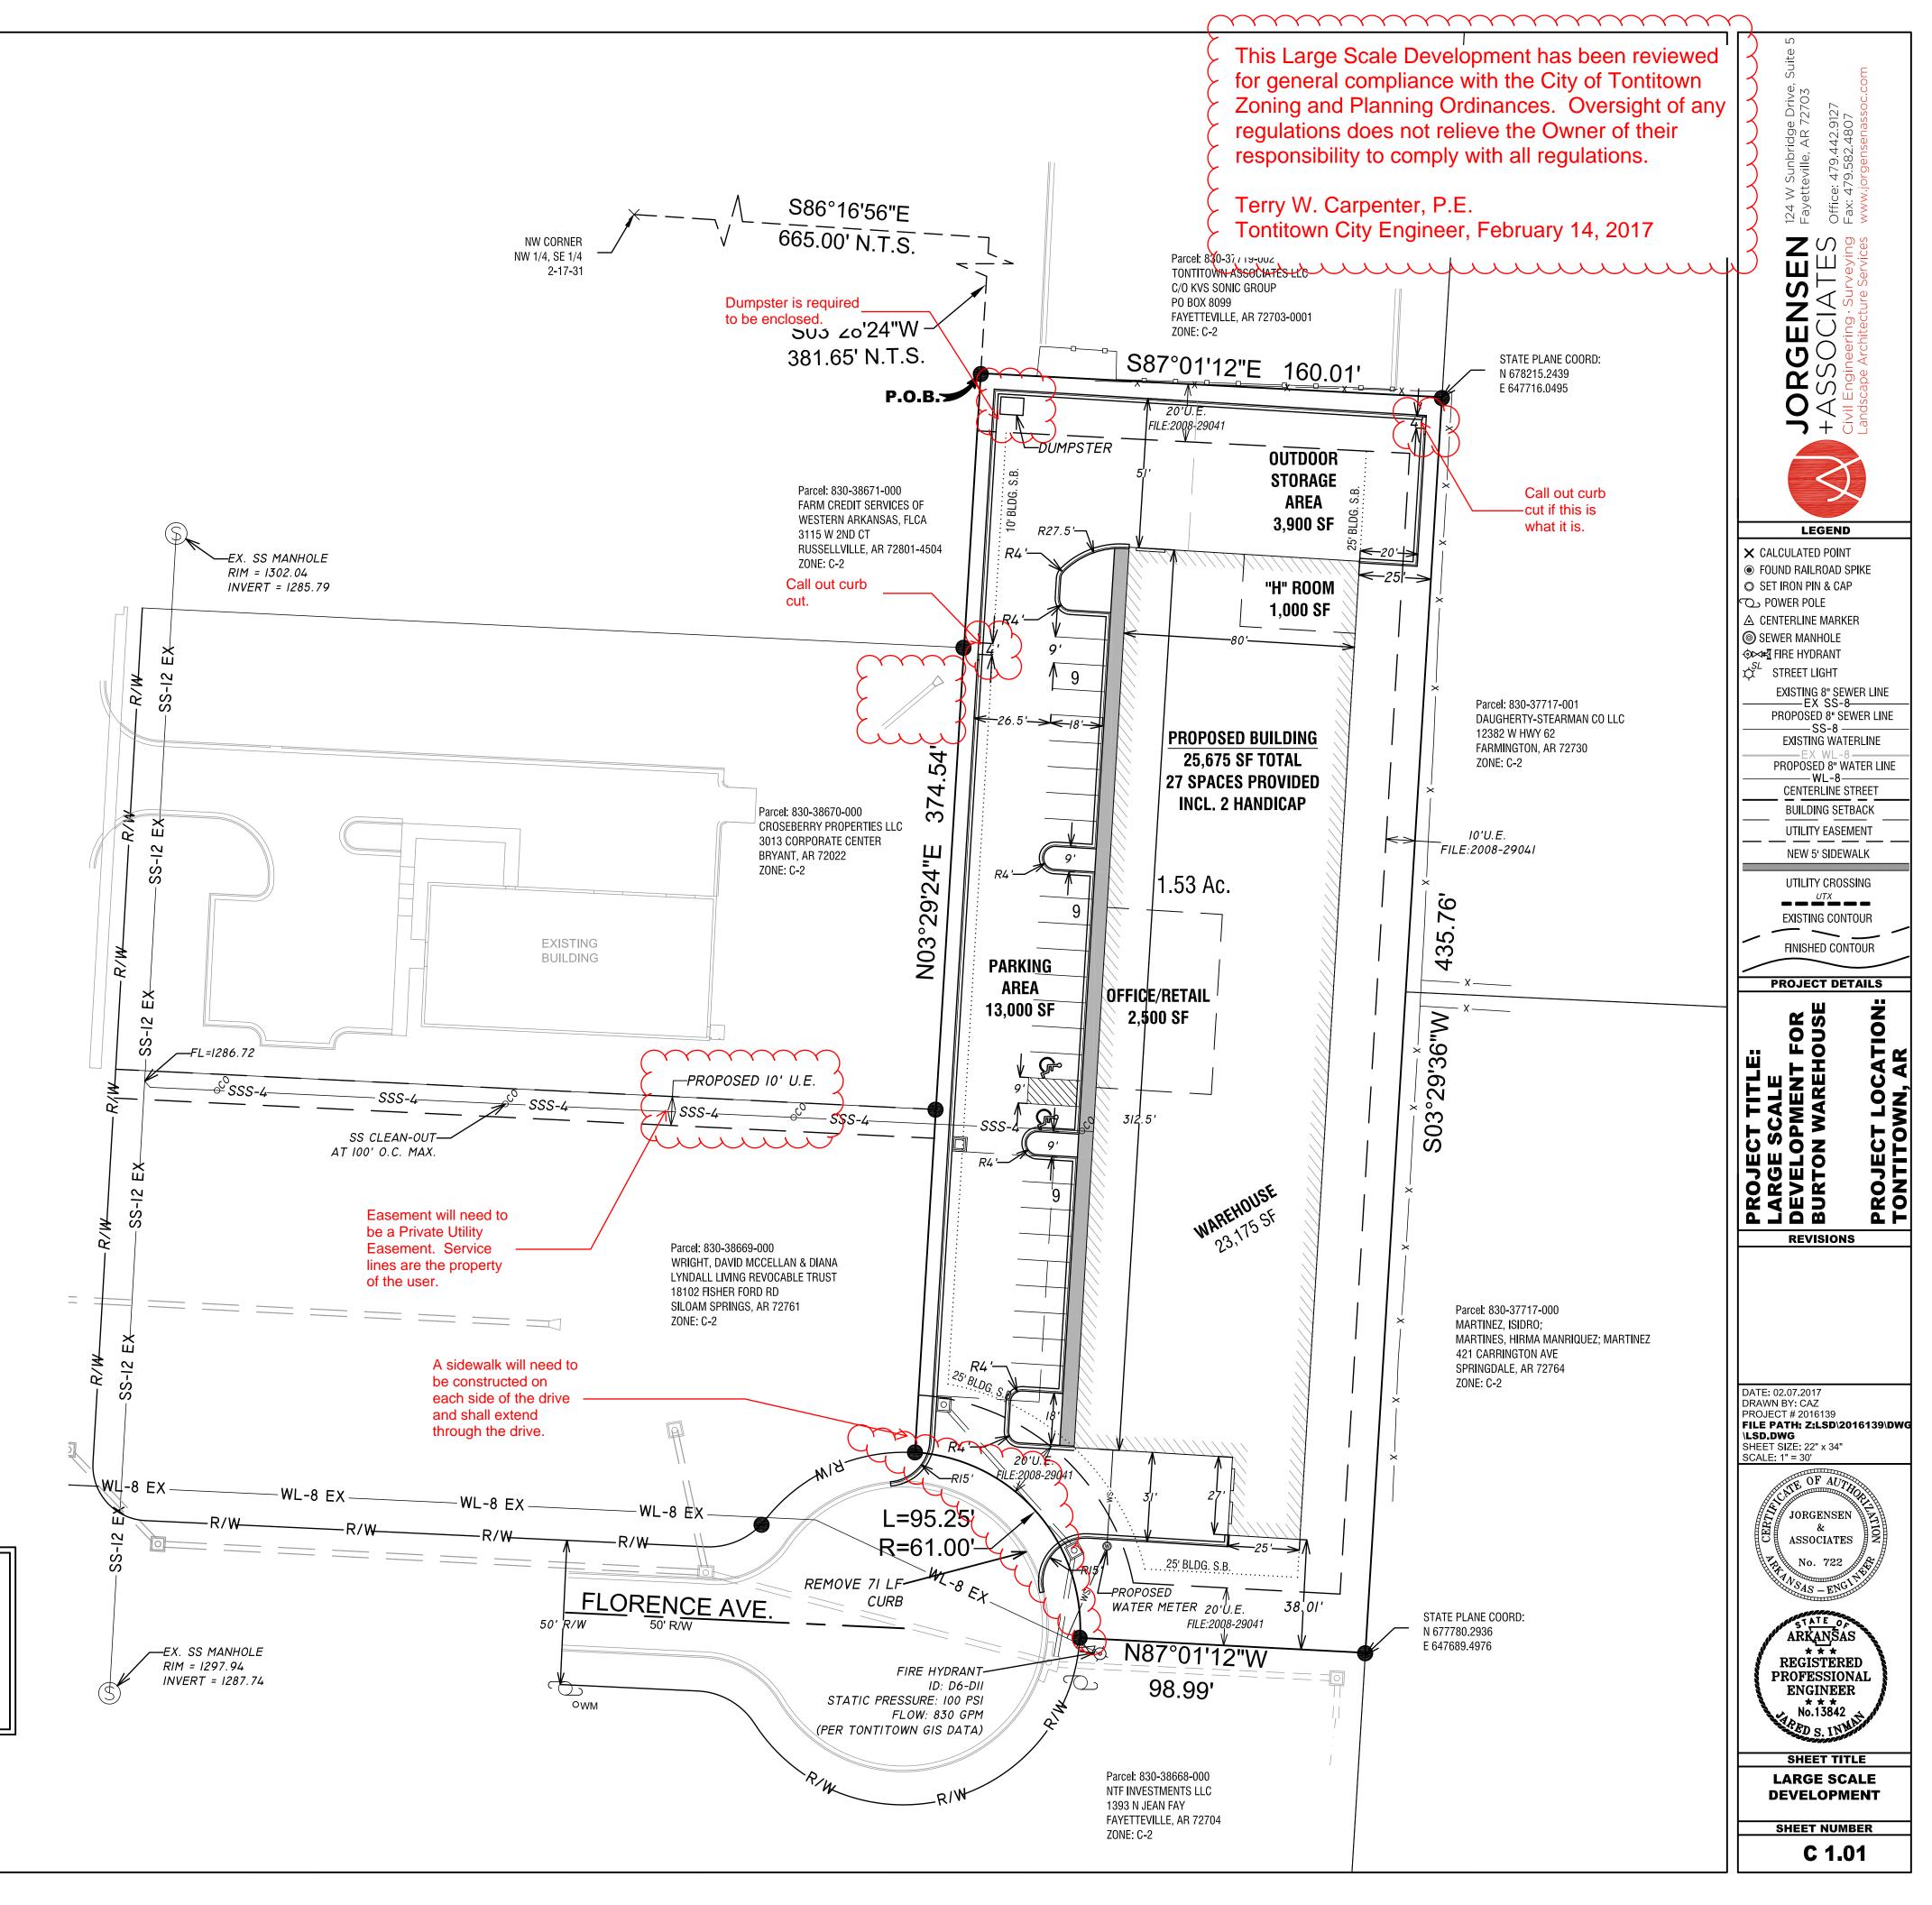


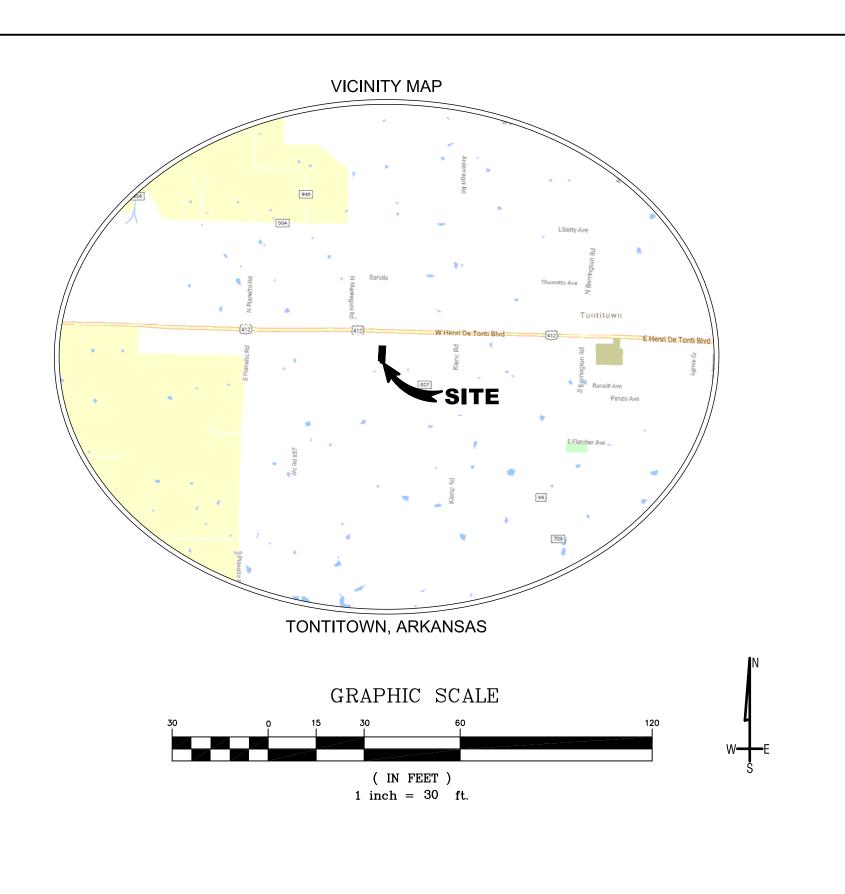

#### GRADING NOTES/ OPERATIONS AND MAINTENANCE PLAN:

- CUTS AND FILLS ARE AS INDICATED BY FINISHED CONTOURS AND SPOT ELEVATIONS. SLOPES SHALL NOT EXCEED 3:1 UNLESS ADDITIONAL SLOPE TREATMENT IS PROPOSED AND

- EXCESSIVE DUST BECOMES A PROBLEM, A PLAN FOR WATERING HEAVILY TRAVELED AREAS WILL BE SUBMITTED TO THE CITY ENGINEER BY THE CONTRACTOR.
- CONTRACTOR SHALL MODIFY EROSION CONTROL MEASURES AS NECESSARY TO ELIMINATE SEDIMENTATION FROM LEAVING THE SITE.
- ALL AREAS WHICH RECEIVE CONCENTRATED RUNOFF SHALL BE STABILIZED WITH STONE CHECK DAMS
- 10) ALL IMPORTED FILL SHALL BE FREE OF ROCKS GREATER THAN 12 INCHES IN DIAMETER AND ANY DETRIMENTAL ORGANIC MATERIAL OR REFUSE DEBRIS
- MECHANICAL COMPACTION.
- STORM DRAINAGE SYSTEMS. STORM DRAINAGE SYSTEMS DOWNSTREAM OF A DEVELOPMENT SITE SHOULD BE PROTECTED FROM DEBRIS, MUD, OR SOIL IN THE EVENT THAT DEBRIS, MUD, OR SOIL REACHES THE DOWNSTREAM DRAINAGE SYSTEM.
- 13) ALL GRADED AND OTHERWISE DISTURBED AREAS SHALL BE STABILIZED WITHIN 15 DAYS IMMEDIATELY AFTER GRADING OR DISTURBANCE HAS CEASED.
- 14) TOP SOIL OR OTHER SOIL THAT IS TO BE STOCKPILED FOR MORE THAN 30 DAYS, SHALL RECIEVE A TEMPORARY COVER OF ANNUAL RYE OR OTHER SUITABLE GRASS SHALL BE PLANTED.
- 15) PERMANENT IMPROVEMENTS SUCH AS STREETS, STORM SEWERS, CURB AND GUTTERS, AND OTHER FEATURES FOR CONTROL OF RUNOFF SHALL BE SCHEDULED COINCIDENTAL TO
- MINIMUM AVERAGE DIAMETER OF 3". IF THERE IS AN EXISTING CURB, LOOSE MATERIAL SUCH AS FILL DIRT OR GRAVEL SHALL NOT BE USED TO RAMP UP TO IT FROM THE STREET TEMPORARY WOODEN RAMPS IN FRONT OF CURBS ARE ACCEPTABLE.
- 18) FRANCHISE AND PRIVATE UTILITIES; THE PROPERTY OWNER OR MAIN CONTRACTOR ONSITE WILL BE RESPONSIBLE FOR RESTORING ALL EROSION AND SEDIMENT CONTROL SYSTEMS AND PUBLIC INFRASTRUCTURE DAMAGED OR DISTURBED BY UNDERGROUND PRIVATE OR FRANCHISE UTILITY CONSTRUCTION SUCH AS WATER AND SEWER SERVICE LEADS. TELEPHONE, GAS, CABLE, ETC. EROSION AND SEDIMENT CONTROL SYSTEMS MUST BE IMMEDIATELY RESTORED AFTER EACH UTILITY CONSTRUCTION.

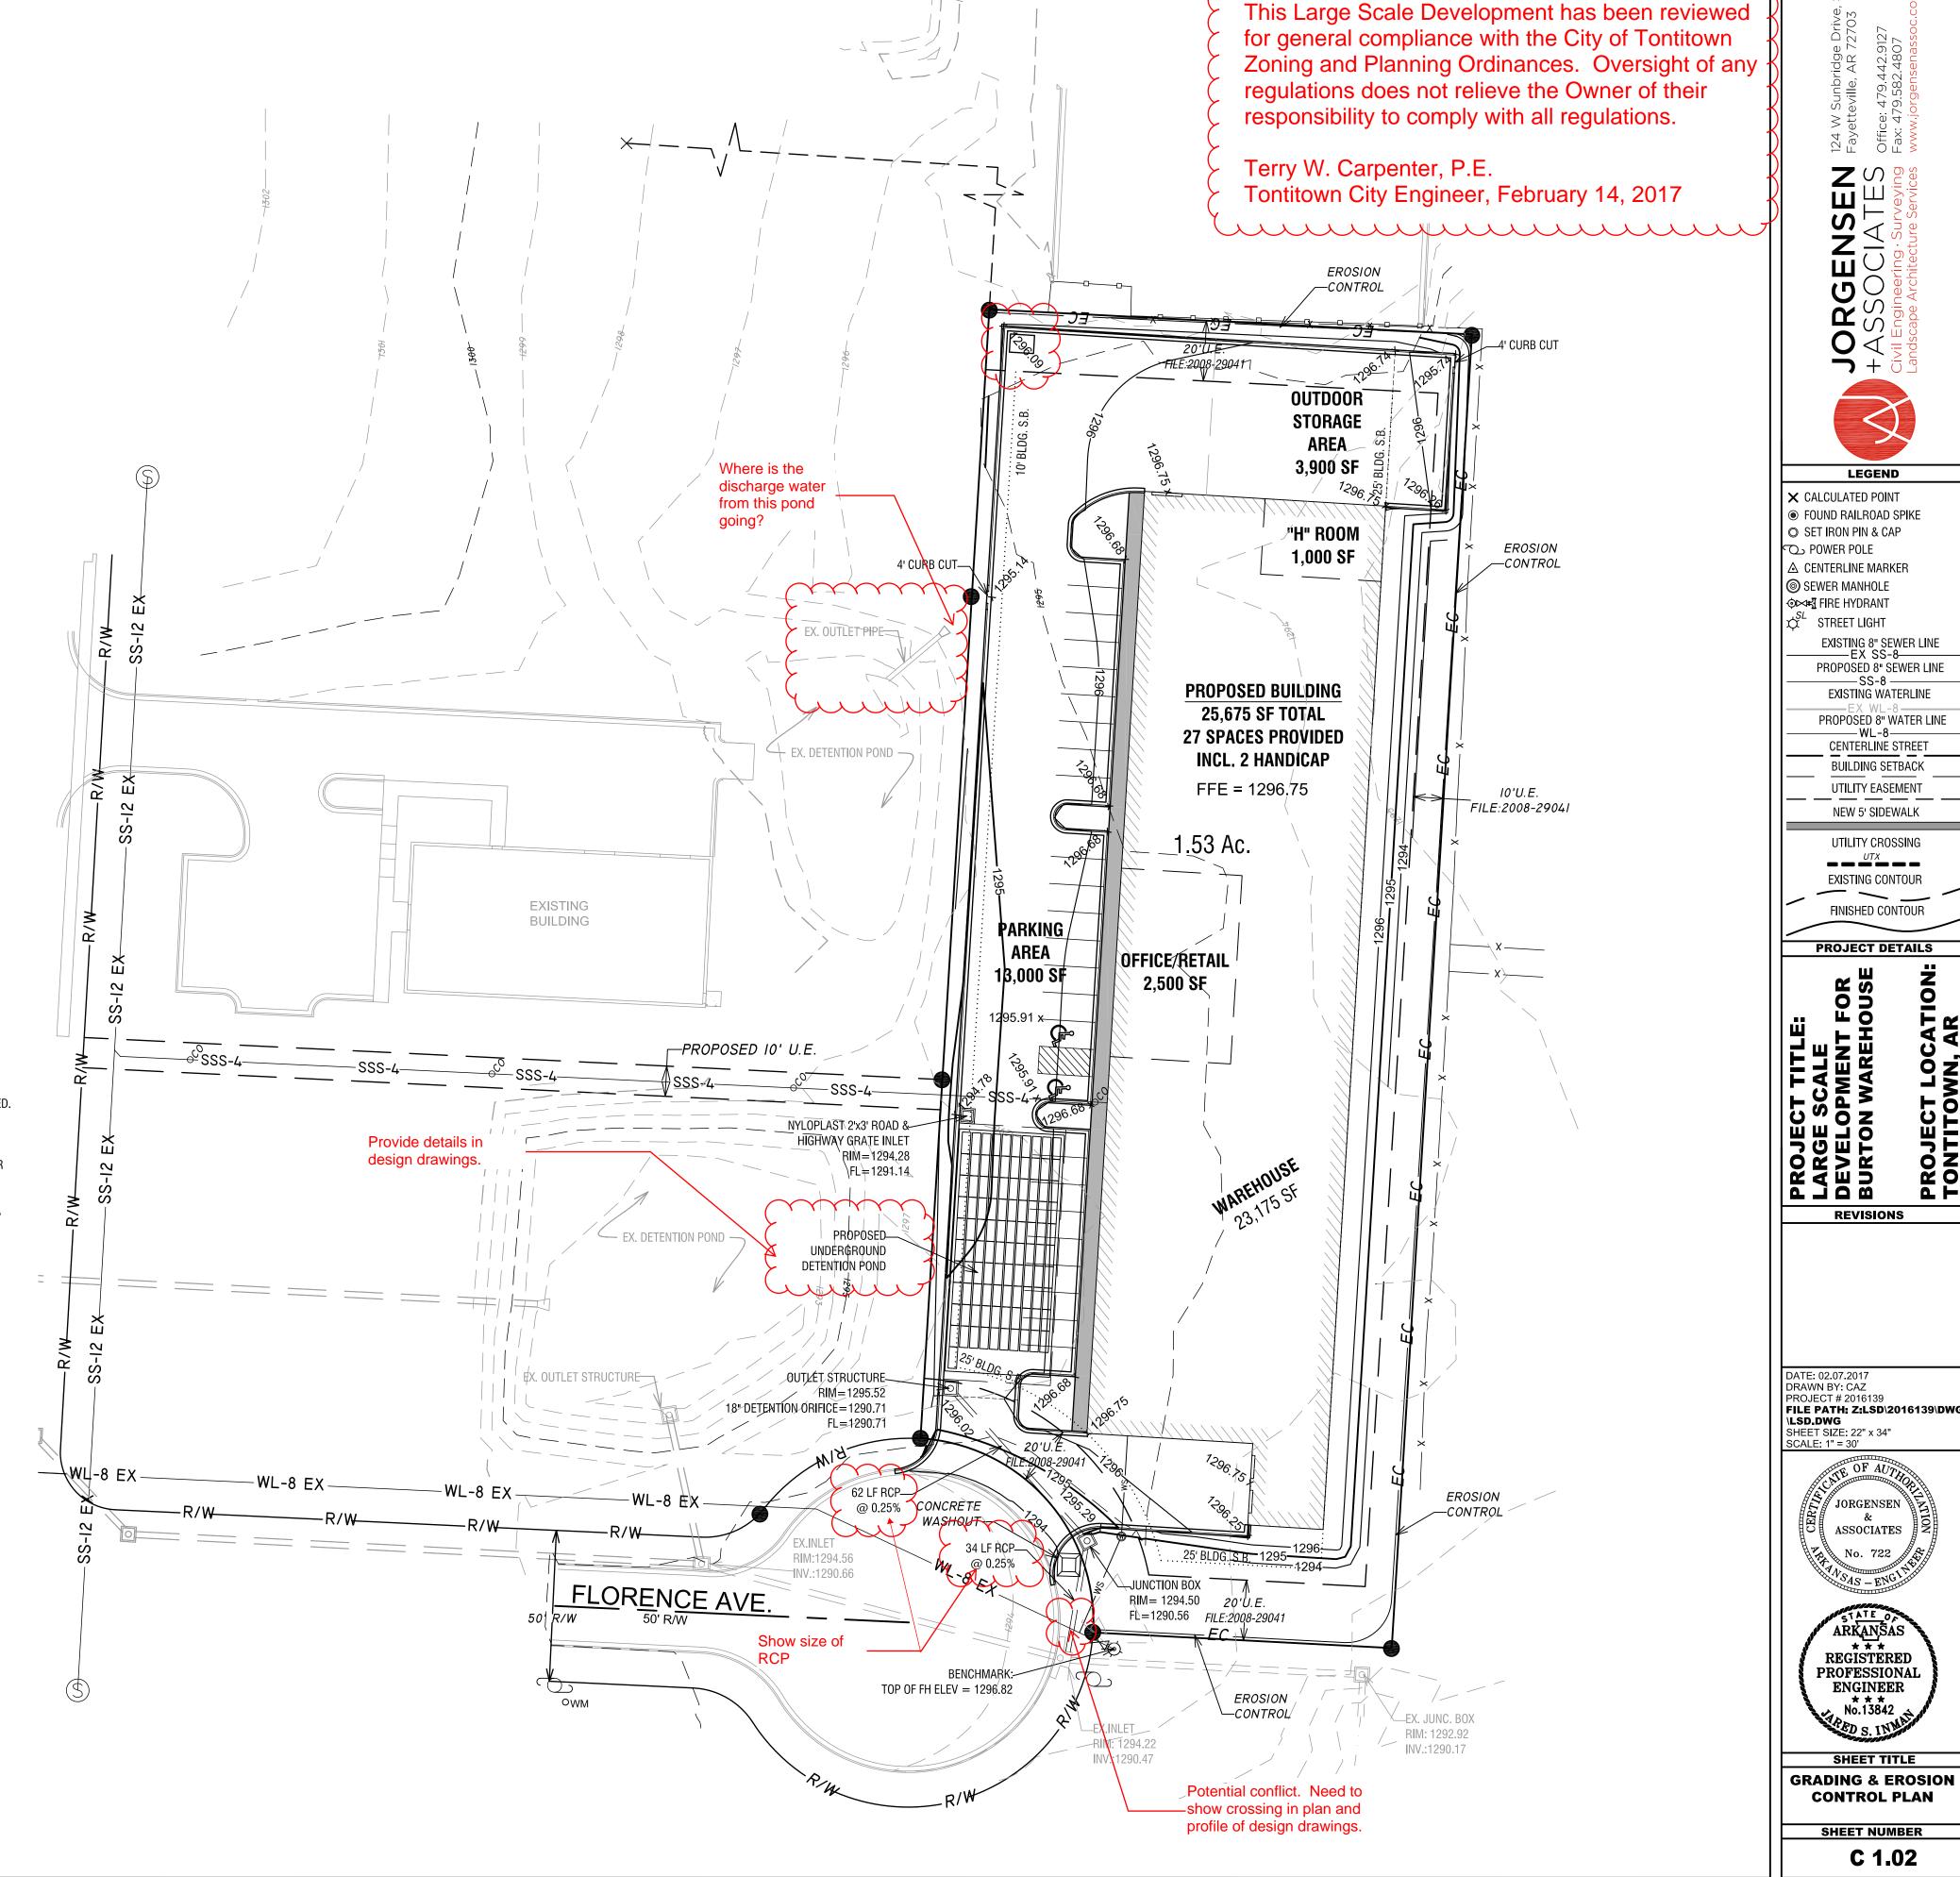

EXISTING 8" SEWER LINE
EX SS-8

PROPOSED 8" SEWER LINE

EXISTING WATERLINE

PROPOSED 8" WATER LINE

CENTERLINE STREET

BUILDING SETBACK

UTILITY EASEMENT

NEW 5' SIDEWALK

UTILITY CROSSING UTX EXISTING CONTOUR

FINISHED CONTOUR

PROJECT DETAILS

REVISIONS

DRAWN BY: CAZ

\LSD.DWG

PROJECT # 2016139

SHEET SIZE: 22" x 34" SCALE: 1" = 30'

<sup>9</sup> JORGENSEN

ASSOCIATES

ARKANSAS REGISTERED


**PROFESSIONAL ENGINEER** 


SHEET TITLE **GRADING & EROSION** 


**CONTROL PLAN** 

SHEET NUMBER

C 1.02

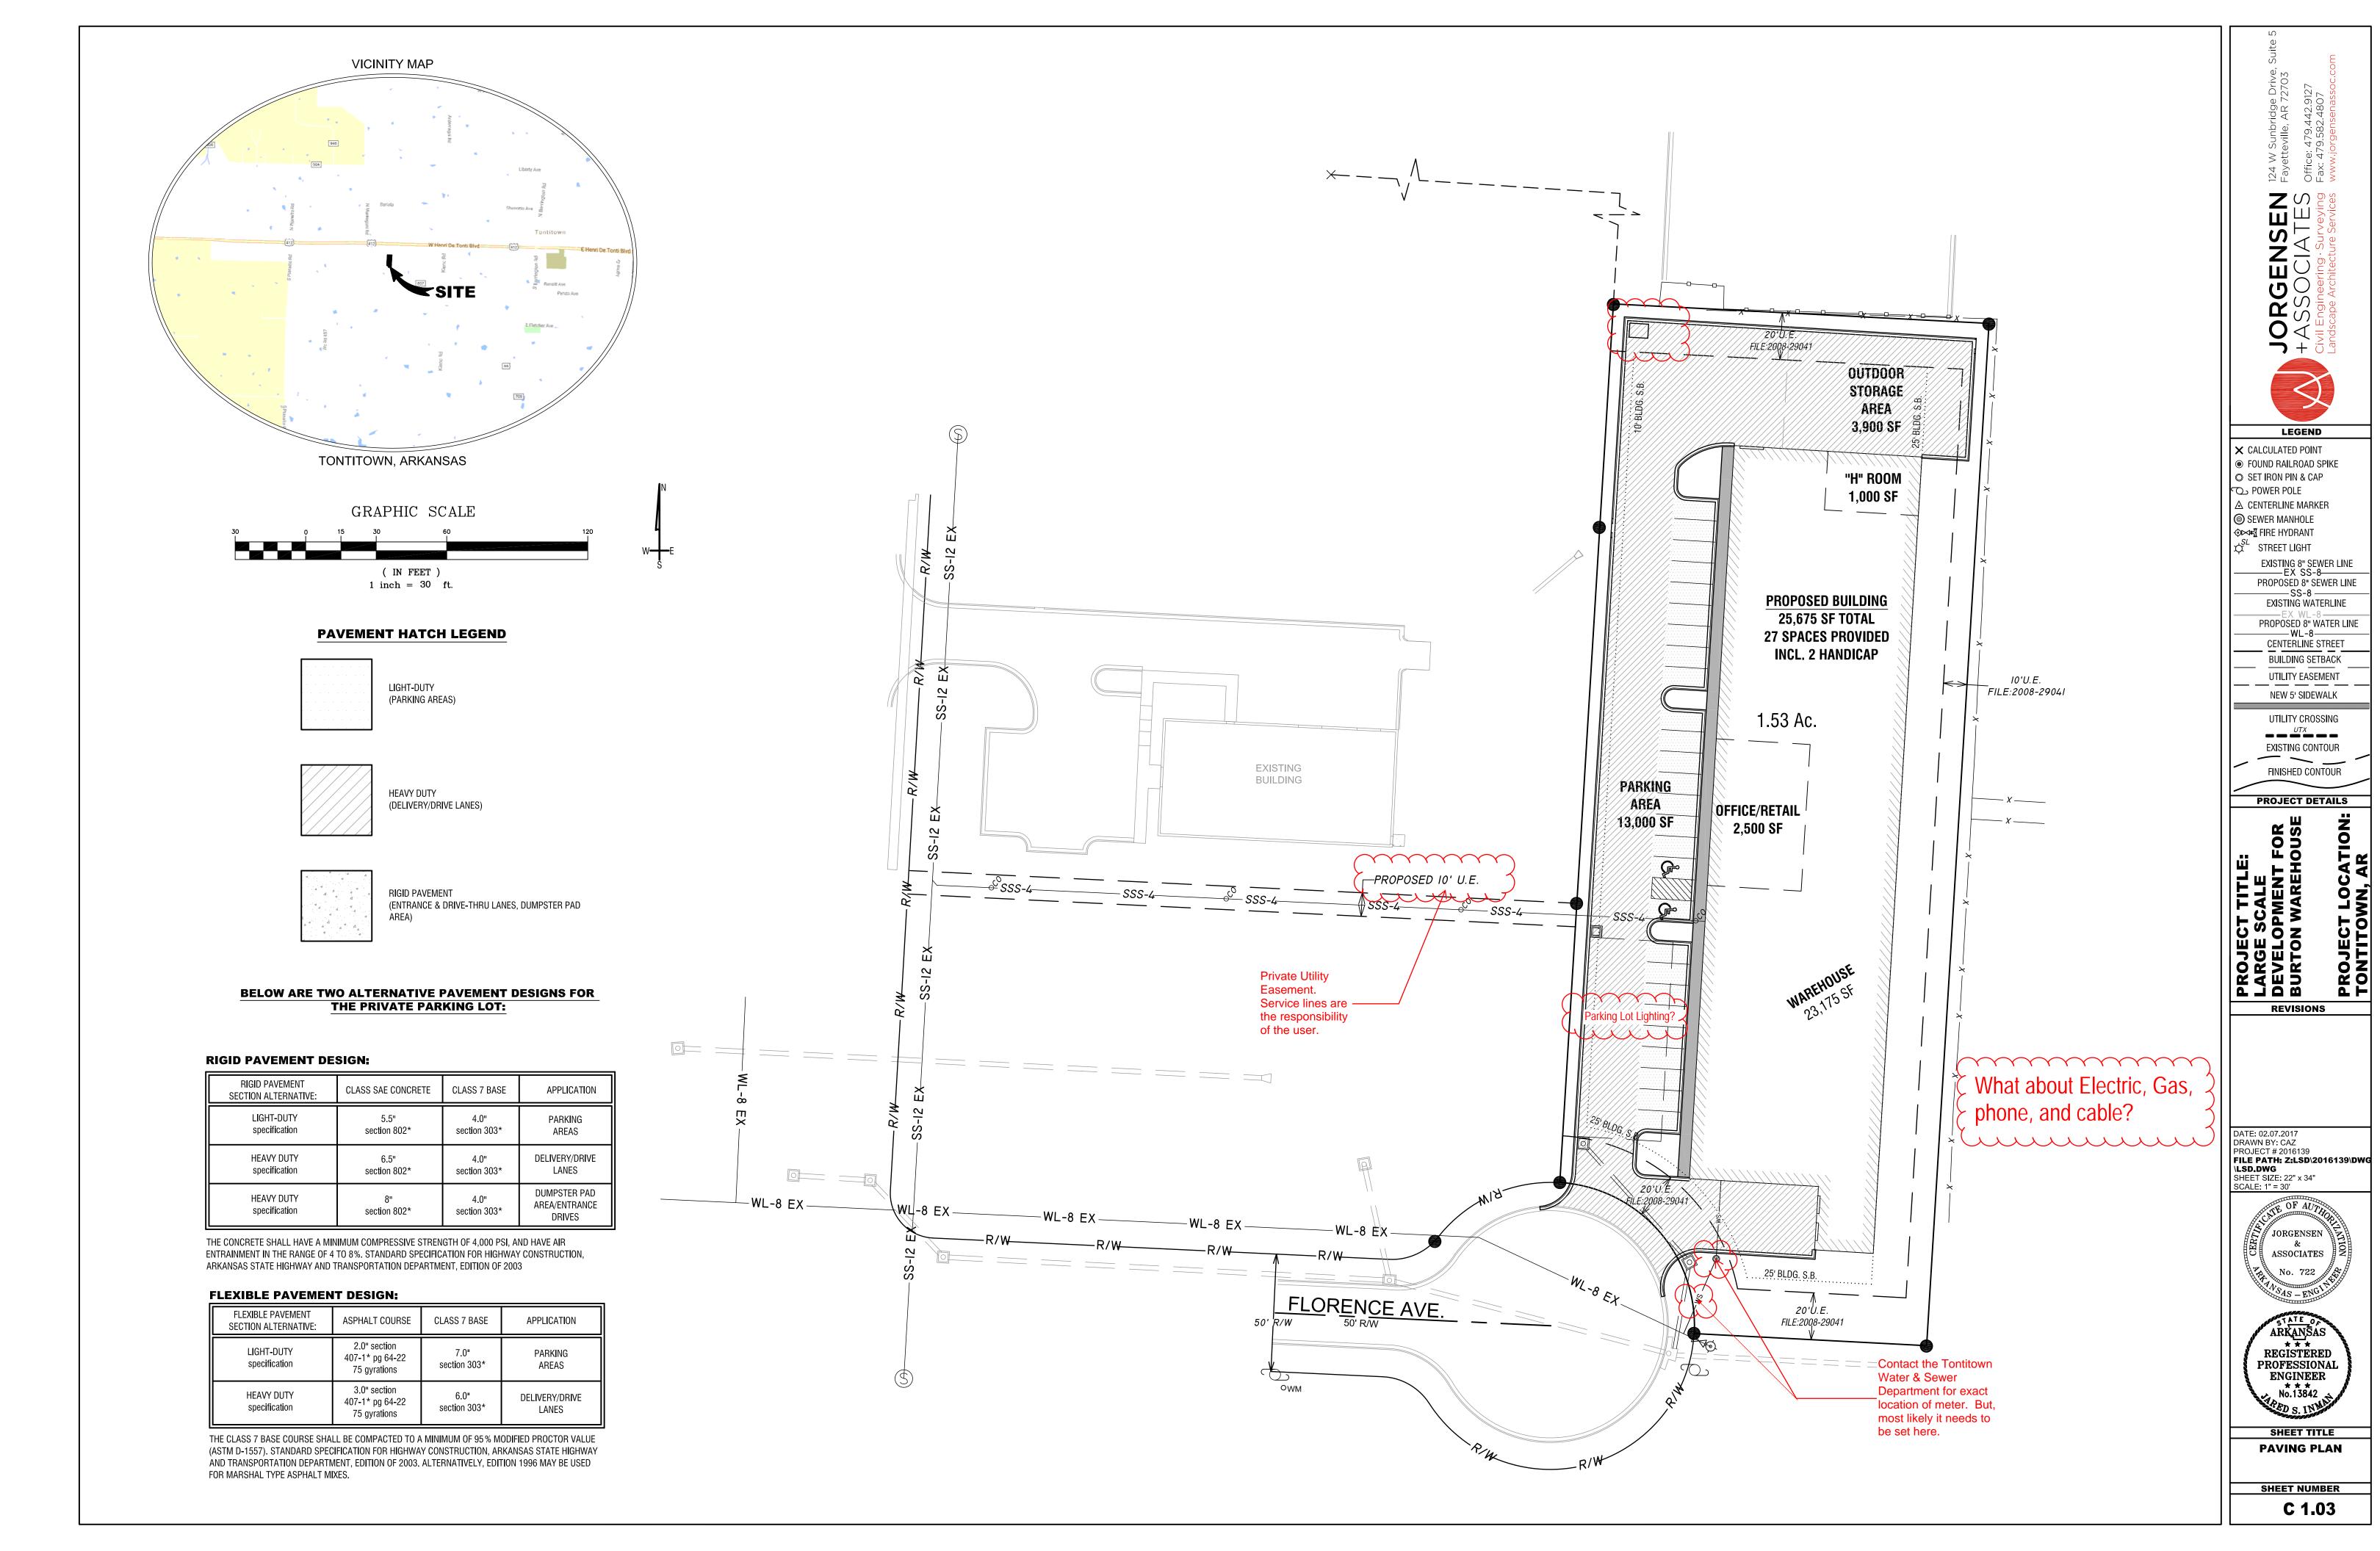

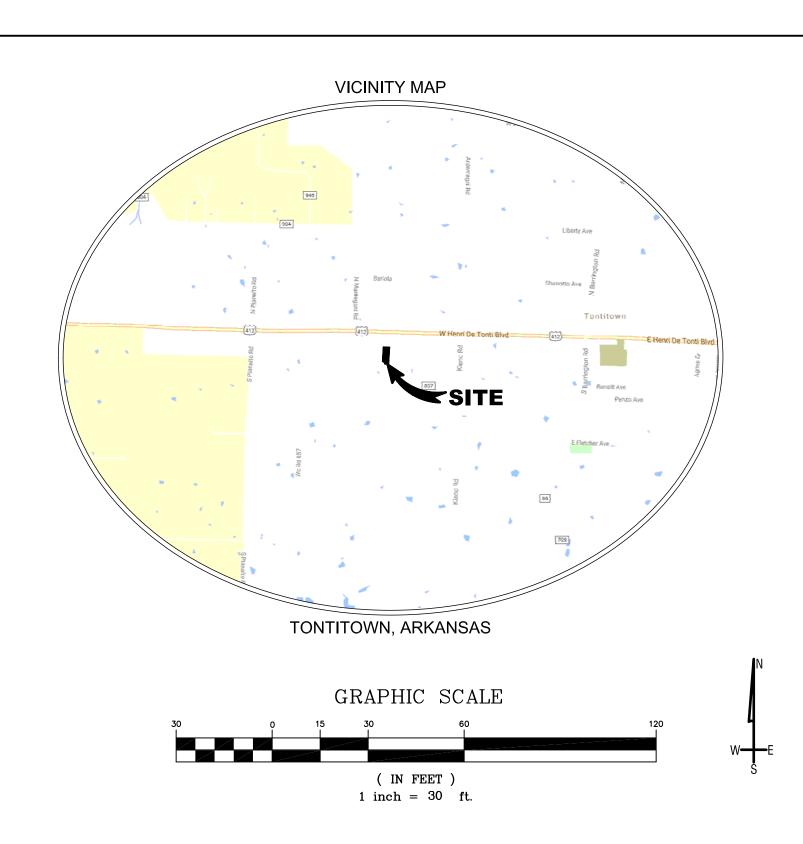

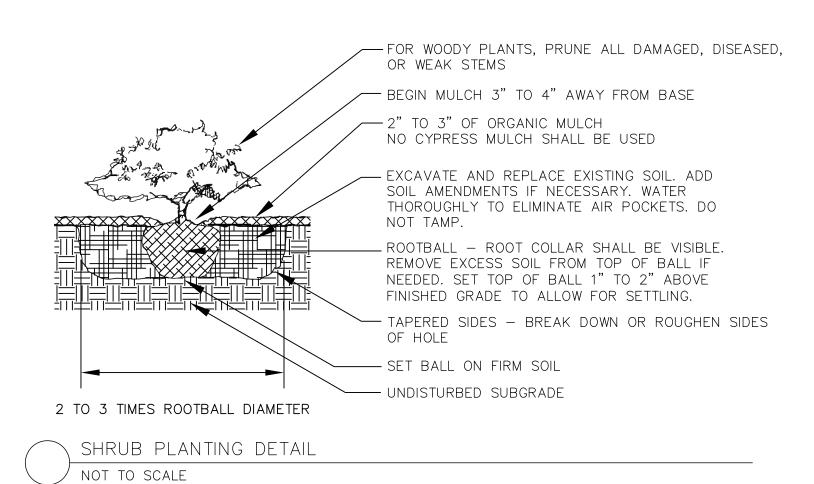

1. TREES SHALL BE 2" CALIPER MINIMUM.

2. THE HOLE FOR THE TREE SHALL BE EXCAVATED 2-3 TIMES THE SIZE OF THE ROOT BALL. 3. STAKE ONLY IF NECESSARY AND AS DIRECTED BY THE PROJECT MANAGER. 4. REMOVE ANY TWINE, ROPE, FLAGGING, WRAPPING, OR GUARDS FROM TREE. 5. PRUNE ONLY DEAD OR BROKEN BRANCHES OR DOUBLE LEADERS AT TIME OF PLANTING. 6. ROOTBALL - ROOT COLLAR SHALL BE VISIBLE. REMOVE EXCESS SOIL FROM TOP OF BALL IF NEEDED. SET TOP OF BALL 1" TO 2" ABOVE FINISHED GRADE TO ALLOW FOR SETTLING. AFTER SETTING BALL IN PLANTING HOLE, CUT AWAY OR REMOVE THE ENTIRE WIRE BASKET. CUT OR REMOVE ALL ROPES OR TWINE FROM BALL. CUT AWAY OR REMOVE BURLAP. IF ROOTBALL BEGINS FALLING APART DURING INSTALLATION OR WHILE REMOVING THE WIRE BASKET, CUT AWAY ONLY HALF OF THE BURLAP. - SET TREE PLUMB SO THE MAIN LEADER IS STRAIGHT - BEGIN MULCH 3" TO 4" AWAY FROM TRUNK 2" TO 3" OF ORGANIC MULCH. NO CYPRESS MULCH SHALL BE USED. BUILD 4" HIGH EARTHEN RING AT THE OUTER EDGE OF TREE'S DRIPLINE EXCAVATE AND REPLACE EXISTING SOIL. ADD SOIL AMENDMENTS IF NECESSARY AS DIRECTED BY PROJECT MANAGER. WATER THOROUGHLY TO ELIMINATE AIR POCKETS. DO NOT TAMP. WIDE SHALLOW HOLES WITH TAPERED SIDES. BREAK DOWN OR ROUGHEN SIDES OF THE HOLE. SET BALL ON FIRM SOIL - UNDISTURBED SUBGRADE

LANDSCAPE REQUIREMENTS STREET FRONTAGE BUFFER (10 FOOT STRIP) 95 LF FRONTAGE / 25 = 3.8 x 10 = 38 SHRUBS REQUIRED (38 SHRUBS PROVIDED)

95 LF FRONTAGE / 50 = 4 TREES REQUIRED (4 TREES PROVIDED)


PREIMETER TREES (REAR / SIDES) 1,069 FL / 50 = 21 TREES REQUIRED (21 TREES PROVIDED)

INTERIOR ISLAND PLANTING

13,000 SF PARKING AREA  $\times$  8% = 1,040 SF ISLAND REQUIRED (1,048 SF PROVIDED)

Developer is required to provide a three year guarantee from the time of installation. See Section 152.195(B)(9)

		PLANT LIST					
		QTY	SYM	COMMON NAME/ BOTANICAL NAME	ROOT	MIN. SIZE	NOTES
~~ (	$\left\langle \cdot \cdot \right\rangle$	4	J.	LONDON PLANE TREE Platanus x acerifolia	B&B	2" CAL.	
		21	SM	SUGAR MAPLE Acer saccharum	В&В	2" CAL	
	$(\cdot)$	4	GR	GOLDEN RAIN TREE Koelreuter <b>ia paniculata</b>	B&B	2" CAL	
		19	Ξ	INKBERRY HOLLY Ilex glabra	CONT.	3 GAL.	
		19	AB	ABELIA GRANDIFLORA Abelia x grandiflora	CONT.	3 GAL.	

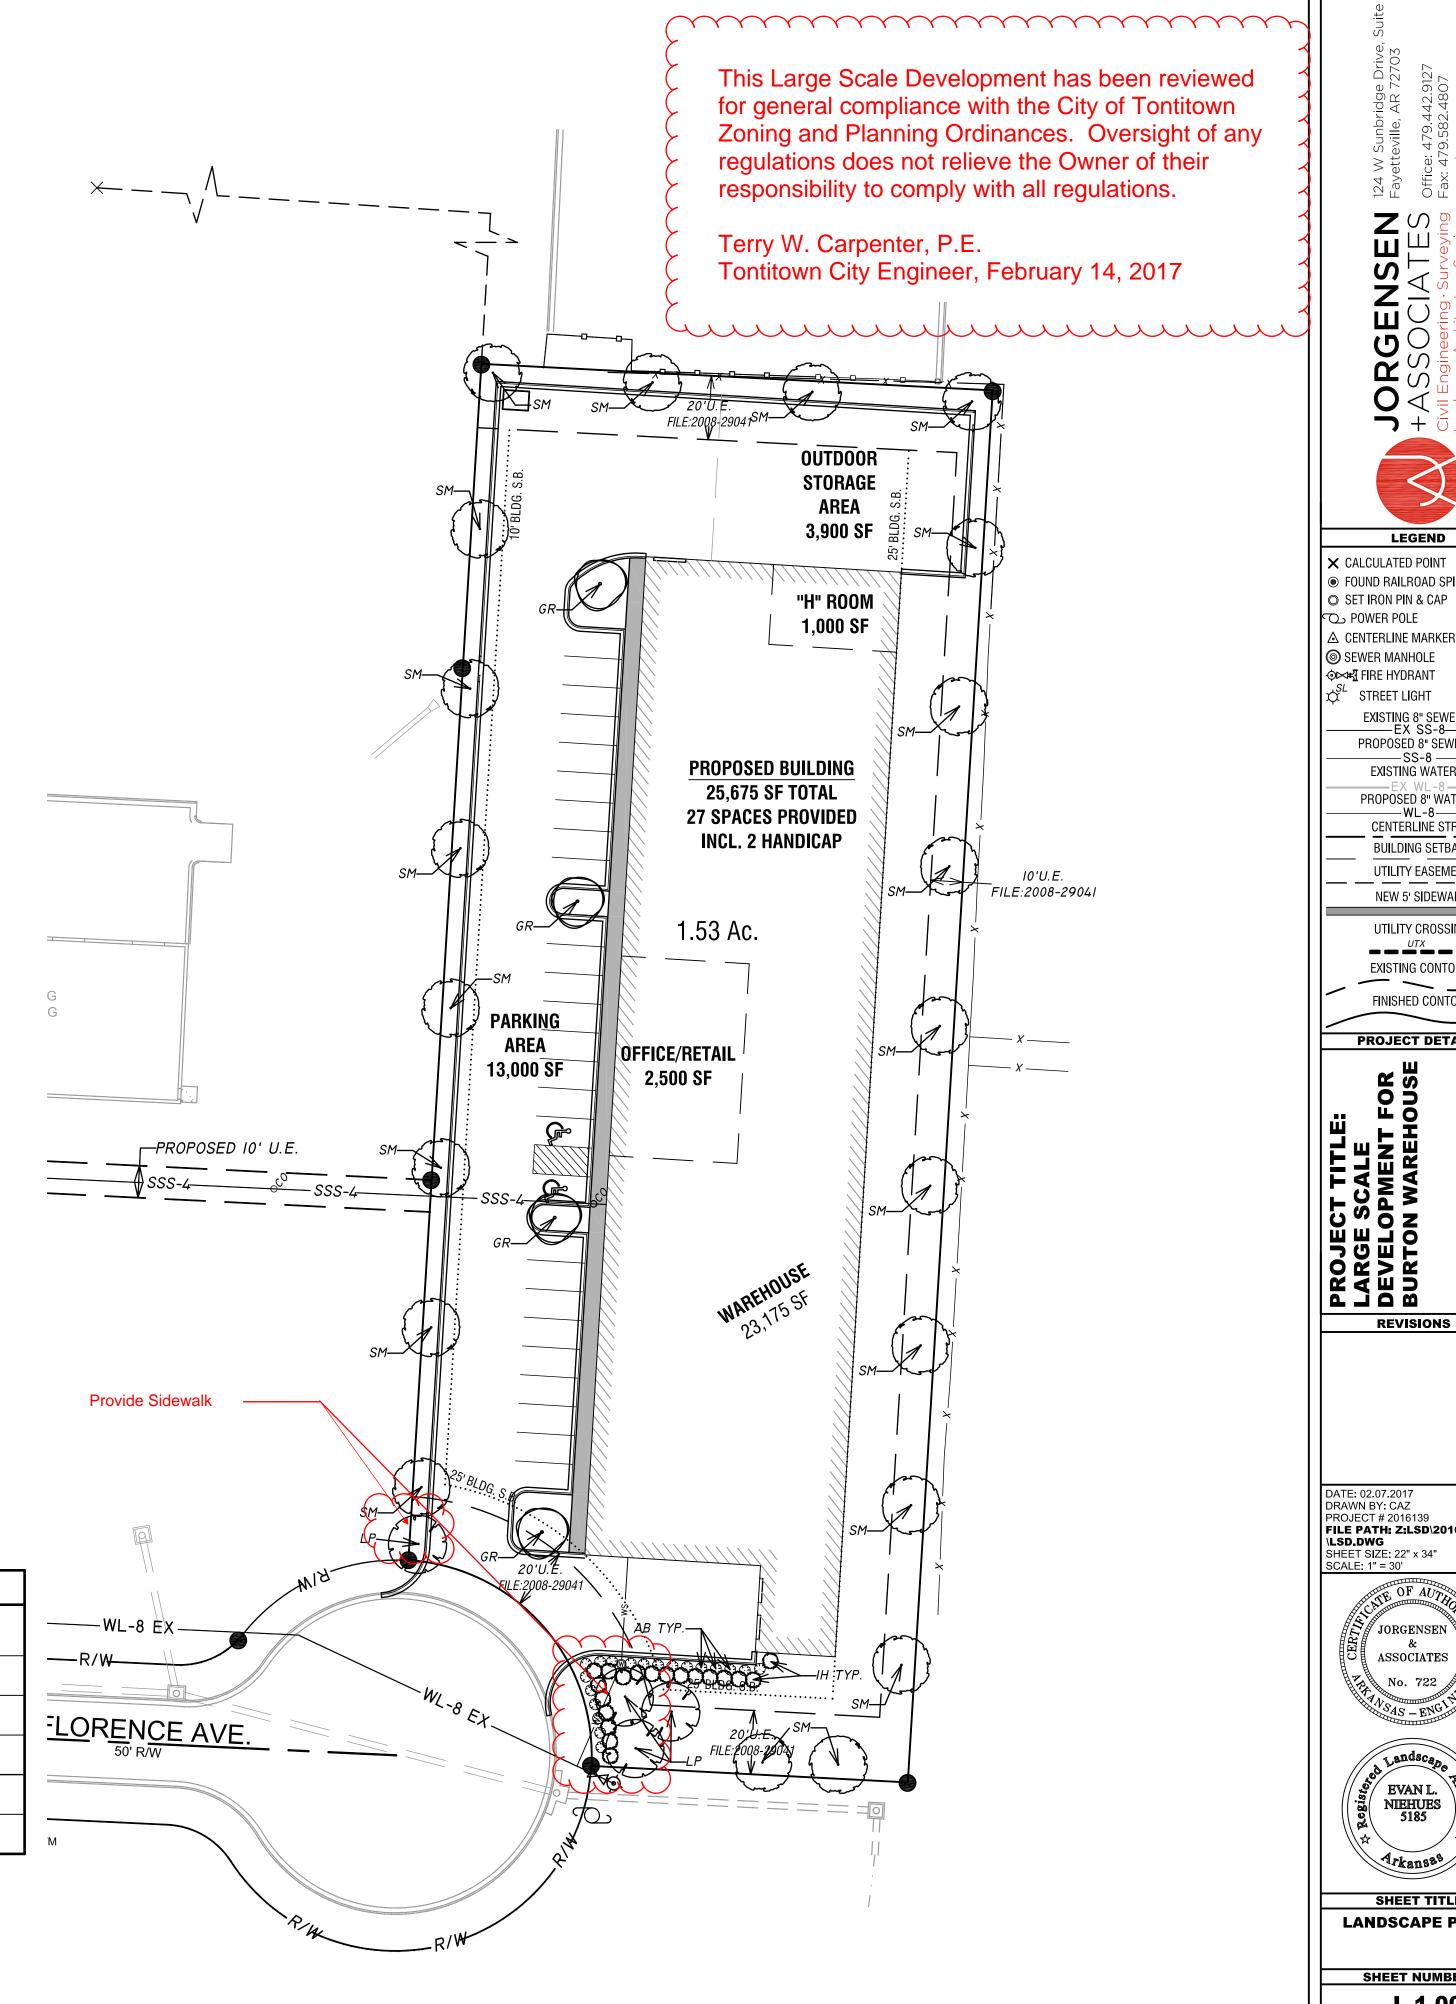

JORGENSEN +ASSOCIATES

LEGEND

EXISTING 8" SEWER LINE
EX SS-8

PROPOSED 8" SEWER LINE

EXISTING WATERLINE

PROPOSED 8" WATER LINE

CENTERLINE STREET

BUILDING SETBACK UTILITY EASEMENT

NEW 5' SIDEWALK

UTILITY CROSSING UTX

EXISTING CONTOUR

FINISHED CONTOUR

PROJECT DETAILS

**REVISIONS** 

DRAWN BY: CAZ

SCALE: 1" = 30'

\LSD.DWG

PROJECT # 2016139

SHEET SIZE: 22" x 34"

| FILE PATH: Z:LSD\2016139\DW(

<sup>9</sup> JORGENSEN

ASSOCIATES

EVAN L.

NIEHUES

Arkansas

SHEET TITLE

SHEET NUMBER

L 1.00

LANDSCAPE PLAN


FOUND RAILROAD SPIKE

○ SET IRON PIN & CAP

© SEWER MANHOLE �**⊳⊭**∰ FIRE HYDRANT

TREE PLANTING DETAIL NOT TO SCALE

2 TO 3 TIMES ROOTBALL DIAMETER

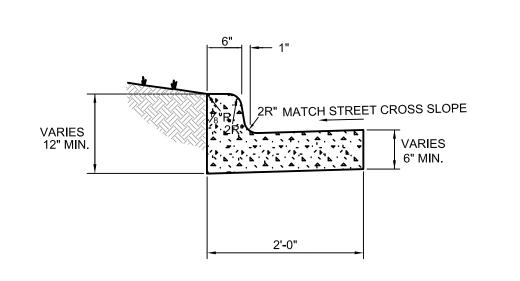

NOT TO SCALE

MATCH STREET CROSS SLOPE

VARIES
6" MIN.

2'-0"

VARIES
6" MIN.

2'-0"

TO BE USED AT STREET

TYPE II

NOT TO SCALE


NOTES:

TYPE I

1. CONCRETE FOR CURB AND GUTTER TO BE CLASS A, 3000 PSI, 5.5 BAG MIX WITH 4-7 % AIR ENTRAINMENT.

2. ALL CURB AND GUTTER SHALL HAVE A BROOMED FINISH UNLESS OTHERWISE SPECIFIED.

- 3. MODIFIED CURB (TYPE I) SHALL BE PLACE ACROSS ALL DRIVEWAY ENTRANCES.
- 4. MODIFIED CURB (TYPE II) SHALL BE PLACED ACROSS ALL SIDE STREETS WHERE THE LONGITUDINAL GRADE IS LESS THAN 1 %.
- 5. SAW CUT JOINTS AT 15' O.C. SEAL WITH ONE PART COLD APPLIED SILICONE JOINT SEALER OR OTHER APPROVED SEALANT. ALL JOINTS TO BE SEALED PRIOR TO FINAL ASPHALT PLACEMENT.
- 6. PROVIDE 1/2" PREFORMED EXPANSION JOINT MATERIAL (ASPHALT IMPREGNATED FIBERBOARD OR OTHER APPROVED MATERIAL) AT STATIONARY STRUCTURES, (DROP INLETS, END OF CURBS, DRIVEWAYS SEE DETAIL) OR AS DIRECTED BY ENGINEER.

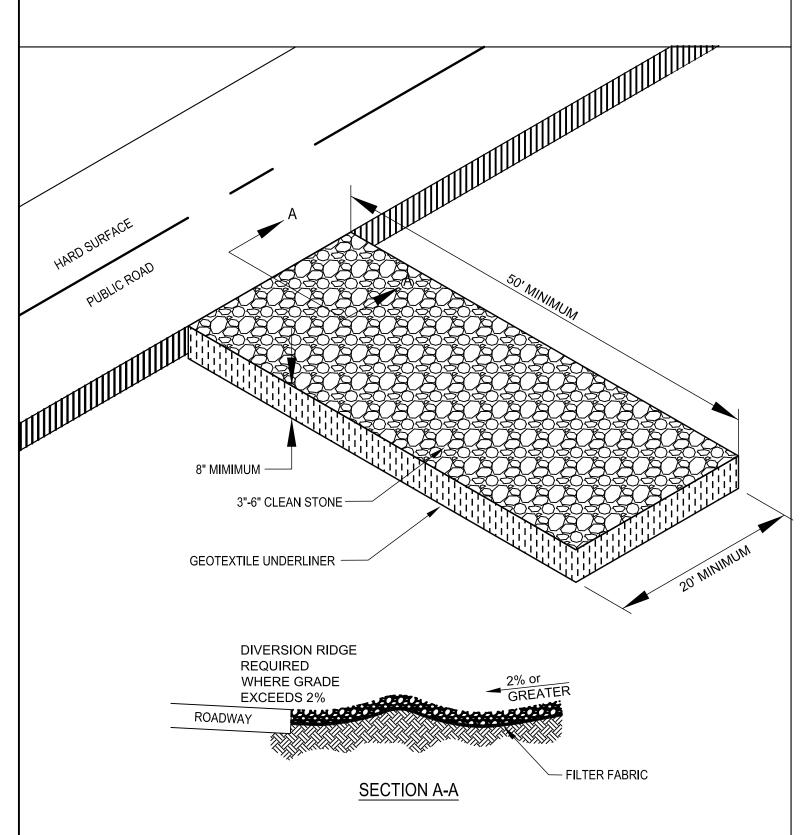



### CONSTRUCTION EXIT NOTES

- 1. REPLACE CONTAMINATED STONE AS REQUIRED TO PREVENT TRACKING OF SEDIMENT OR MUD ON
- PUBLIC STREETS.

  2. CLEAN STREETS DAILY WITH BROOM AND SHOVEL. THE USE OF WATER IS PROHIBITED.
- CLEAN STREETS DAILY WITH BROOM AND SHOVE
   ALL VEHICLES MUST USE CONSTRUCTION EXIT.
- 4. WHEN WHEEL WASHING IS REQUIRED, IT SHALL BE DONE ON AN AREA STABILIZED WITH CRUSHED STONE THAT DRAINS INTO AN APPROVED SEDIMENT TRAP OR SEDIMENT BASIN.

CONSTRUCTION EXIT

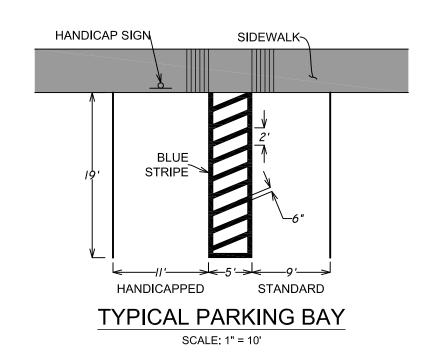

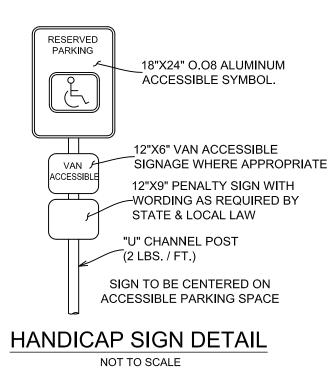


NOTES:

1. THE LENGTH OF THE RAMP SHALL BE SUCH THAT THE SLOPE DOES NOT EXCEED 12:1.


2. THE MINIMUM THICKNESS FOR THE RAMP, WALK, &

LANDING SHALL BE 4".

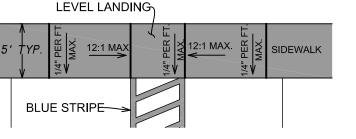


WHEELCHAIR RAMP DETAIL

SCALE: 1" = 10"

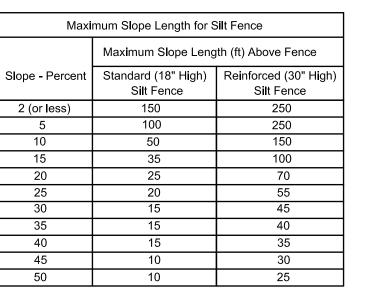

NOTES:

1. THE SLOPE LENGTH SHOWN IS THE DISTANCE FROM THE FENCE
TO THE DRAINAGE DIVIDE OR THE NEAREST UPSLOPE CHANNEL.
2. SLOPE LENGTH CANNOT BE ADDRESSED BY USE OF MULTIPLE

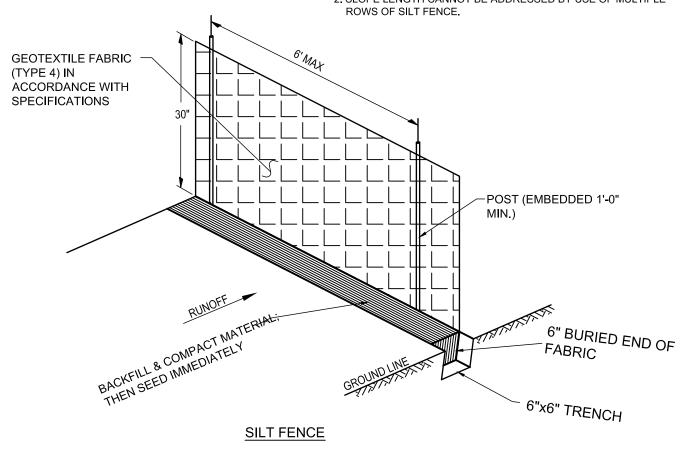


### SILT FENCE NOTES

- 1. POSTS WHICH SUPPORT THE SILT FENCE SHALL BE INSTALLED ON A SLIGHT ANGLE TOWARD THE ANTICIPATED RUNOFF SOURCE. POST MUST BE EMBEDDED A MINIMUM OF ONE FOOT.
- 2. THE TOE OF THE SILT FENCE SHALL BE TRENCHED IN WITH A SPADE OR MECHANICAL TRENCHER, SO THAT THE DOWNSLOPE FACE OF THE TRENCH IS FLAT AND PERPENDICULAR TO THE LINE OF FLOW. HERE FENCE CANNOT BE TRENCHED IN (e.g.
- PAVEMENT), WEIGHT FABRIC FLAP WITH ROCK ON UPHILL SIDE TO PREVENT FLOW FROM SEEPING UNDER FENCE.


  3. THE TRENCH MUST BE A MINIMUM OF 6 INCHES DEEP AND 6 INCHES WIDE TO ALLOW FOR THE SILT FENCE FABRIC TO BE
- LAID IN THE GROUND AND BACKFILLED WITH COMPACTED MATERIAL.
  4. SILT FENCE SHOULD BE SECURELY FASTENED TO EACH SUPPORT POST OR TO WOVEN WIRE, WHICH IN TURN IS ATTACHED
- TO THE FENCE POST. THERE SHALL BE A 3 FOOT OVERLAP, SECURELY FASTENED WHERE ENDS OF FABRIC MEET.

  5. REPAIR OR REPLACEMENT SHALL BE MADE PROMPTLY AS NEEDED.
- 6. SILT FENCE SHALL BE REMOVED WHEN THE SITE IS COMPLETELY STABILIZED SO AS NOT TO BLOCK OR IMPEDE STORM FLOW OR DRAINAGE.7. ACCUMULATED SILT SHALL BE REMOVED WHEN IT REACHES A DEPTH OF HALF THE HEIGHT OF THE FENCE. THE SILT SHALL BE DISPOSED OF AT AN APPROVED SITE AND IN SUCH A MANNER AS TO NOT CONTRIBUTE TO ADDITIONAL SILTATION.

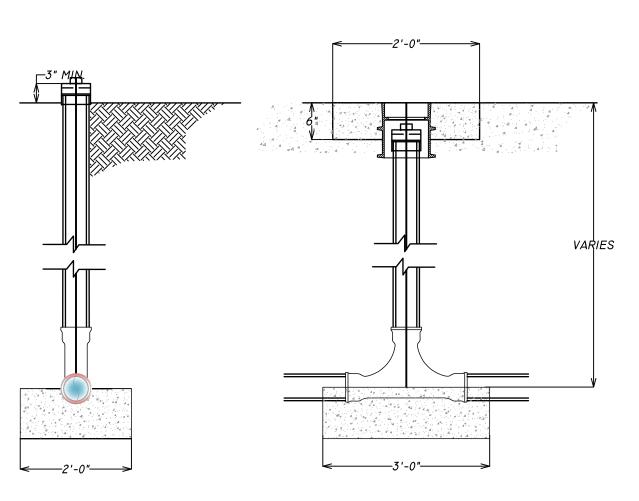

END VIEW

TYPICAL CLEANOUT

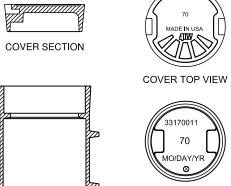

COVER BACK VIEW VALVE BOX SECTION

SIDE VIEW

WASHOUT NOTES

1. NO WASHING OUT OF CONCRETE TRUCKS OR WASHING OF SWEEPINGS FROM EXPOSED AGGREGATE CONCRETE INTO STORM DRAINS, OPEN DITCHES, STREETS, OR STREAMS IS ALLOWED.
2. EXCESS CONCRETE IS NOT ALLOWED TO BE DUMPED ON-SITE, EXCEPT IN DESIGNATED

TEMPORARY CONCRETE WASHOUT PIT AREAS.


3. ON-SITE TEMPORARY CONCRETE WASHOUT AREAS WILL BE LOCATED AT LEAST 50 FEET FROM

STORM DRAINS, OPEN DITCHES, OR WATER BODIES AS DETERMINED IN THE FIELD.

4. TEMPORARY CONCRETE WASHOUT FACILITIES WILL BE CONSTRUCTED AND MAINTAINED IN SUFFICIENT QUANTITY AND SIZE TO CONTAIN ALL LIQUID AND CONCRETE WASTE GENERATED BY

5. WASHOUT FACILITIES WILL BE CLEANED OUT OR REPLACED ONCE THE WASHOUT IS 75 % FULL.
6. PLASTIC LINING MATERIAL WILL BE MINIMUM OF 10 MIL POLYETHYLENE SHEETING AND WILL BE FREE OF HOLES, TEARS, OR OTHER DEFECTS.


7. WHEN WASHOUT FACILITIES ARE NO LONGER REQUIRED FOR WORK, THE HARDENED CONCRETE WILL BE REMOVED AND DISPOSED OF OFFSITE. MATERIALS USED TO CONSTRUCT TEMPORARY CONCRETE WASHOUT FACILITIES WILL BE REMOVED FROM THE SITE AND DISPOSED OF.

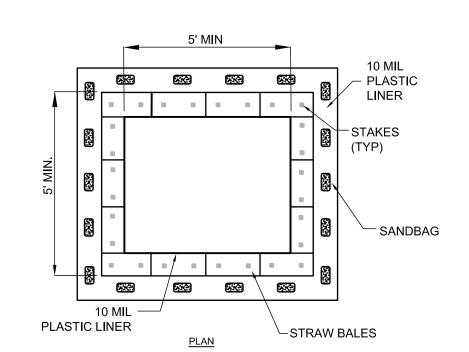

PLASTIC LINER

-NATIVĖ MATERIAL

BINDING WIRE —

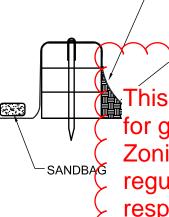

This Large Scale Development has been reviewed for general compliance with the City of Tontitown Zoning and Planning Ordinances. Oversight of any regulations does not relieve the Owner of their responsibility to comply with all regulations.

OTHER MATERIAL

AS APPROVED BY

MAY BE USED

Terry W. Carpenter, P.E. Tontitown City Engineer, February 14, 2017

ORGENSEN 124 W Sunbridg ARASSOCIATES Office: 479.442, vil Engineering Surveying Fax: 479.582.48

+ O T

➤ CALCULATED POINT

■ FOUND RAILROAD SPIKE

■ SET IRON PIN & CAP

TO POWER POLE

Δ CENTERLINE MARKER

△ CENTERLINE MARKER

⑤ SEWER MANHOLE

•••

••

STREET LIGHT

EXISTING 8" SEWER LINE

EX SS-8

PROPOSED 8" SEWER LINE

SS-8

EXISTING WATERLINE

EX WL-8

PROPOSED 8" WATER LINE
WL-8
CENTERLINE STREET
BUILDING SETBACK
UTILITY EASEMENT

UTILITY CROSSING

UTX

EXISTING CONTOUR

NEW 5' SIDEWALK


FINISHED CONTOUR

PROJECT DETAILS

RGE SCALE
VELOPMENT FOR
RTON WAREHOUSE
OJECT LOCATION:

REVISIONS

DATE: 02.07.2017 DRAWN BY: CAZ PROJECT # 2016139 FILE PATH: Z:LSD\2016139\DWG

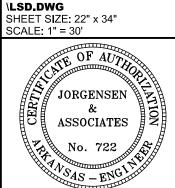

ARKANSAS

REGISTERED

PROFESSIONAL

ENGINEER

No.13842

SHEET TITLE
DETAILS

\_\_\_\_

C 5.01


### JUNCTION BOX NOTES


- 1. ALL EXPOSED CORNERS TO HAVE 3/4" CHAMFER.
- 2. ALL REINFORCEMENT BARS SHALL BE GRADE 60 AND SHALL HAVE A MINIMUM 2" COVER UNLESS OTHERWISE
- 3. CONCRETE SHALL HAVE A MINIMUM COMPRESSIVE STRENGTH OF 3500 p.s.i. -TOP 18" SHALL BE CAST-IN-PLACE.
- 4. INVERTS SHALL BE POURED MONOLITHICALLY WITH FOOTING.
- 5. PIPES MAY ENTER BOX FROM ANY ANGLE OF ELEVATION AS DIRECTED BY THE ENGINEER. REINFORCING BARS
- SHALL BE CUT TO CLEAR PIPE BY 2". 6. STEPS ARE REQUIRED IN STORM DRAIN MANHOLES THAT ARE AT 4 FT OF DEPTH AND GREATER (FROM INVERT
- TO RIM). CENTERLINE OF MANHOLE LID SHALL BE 2 FT FROM THE WALL WHERE STEPS ARE LOCATED. STEPS
- (6" x 12") SHALL BE COPOLYMER POLYPROPYLENE PLASTIC WITH STEEL CORE AT 16" APART.

	(* * * * ) * * * * * * * * * * * * * * *
7.	LIMIT DEFLECTION TO 60 DEGREES. IF GREATER, USE NEXT LARGER MANHOLE DIAMETER/SIZE.

INSIDE DIMENSION	DIAMETER OF OUTLET PIPE	MIN. WALL THICKNESS	*TOP CONCRETE SLAB REINFORCING	MIN. WALL THICKNESS
4'	15" - 18"	6"	# 4'S @ 8" O.C. E.W.	6"
5'	24" - 42"	8"	# 4'S @ 7" O.C. E.W.	8"
6'	48" - 54"	8"	# 5'S @ 9" O.C. E.W.	8"

\* WHEN UNDER TRAFFIC, USE # 5'S @ 6" O.C. E.W.

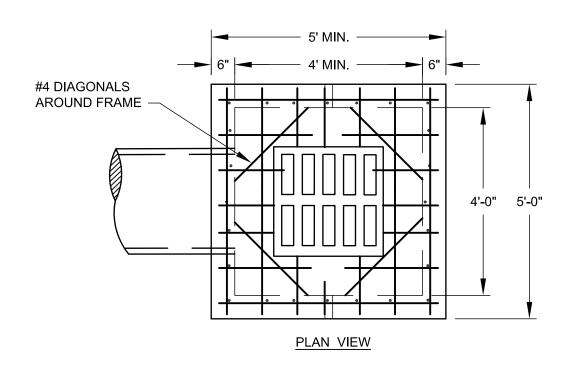

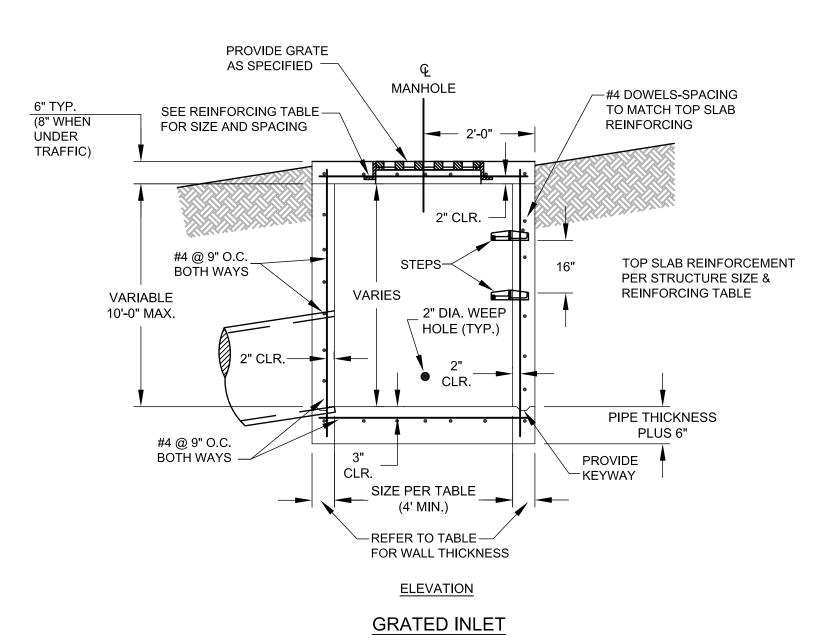

This Large Scale Development has been reviewed for general compliance with the City of Tontitown Zoning and Planning Ordinances. Oversight of any regulations does not relieve the Owner of their responsibility to comply with all regulations.


Terry W. Carpenter, P.E. Tontitown City Engineer, February 14, 2017

#### JUNCTION BOX NOTES

INSIDE

DIMENSION

- 1. ALL EXPOSED CORNERS TO HAVE 3/4" CHAMFER.
- 2. ALL REINFORCEMENT BARS SHALL BE GRADE 60 AND SHALL HAVE A MINIMUM 2" COVER UNLESS OTHERWISE NOTED.
- 3. CONCRETE SHALL HAVE A MINIMUM COMPRESSIVE STRENGTH OF 3500 p.s.i. -TOP 18" SHALL BE CAST-IN-PLACE.
- 4. INVERTS SHALL BE POURED MONOLITHICALLY WITH FOOTING.
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\* WHEN UNDER TRAFFIC, USE # 5'S @ 6" O.C. E.W.

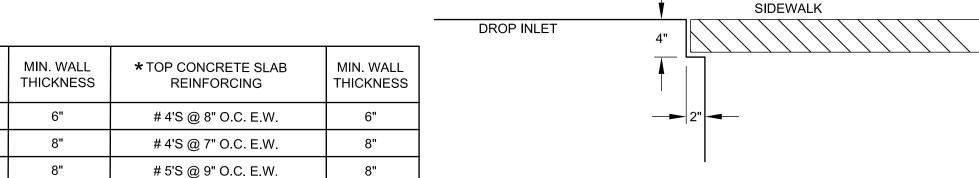DIAMETER OF


**OUTLET PIPE** 

15" - 18"


24" - 42"

48" - 54"

NOTCH FOR SIDEWALKS

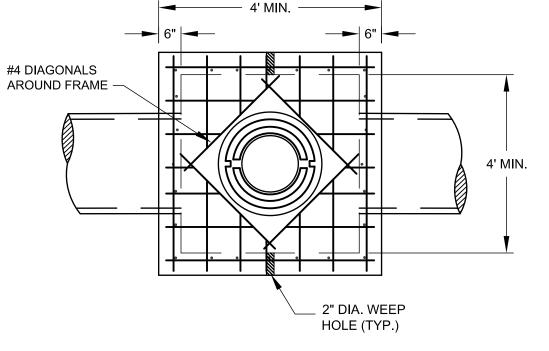

PLAN VIEW

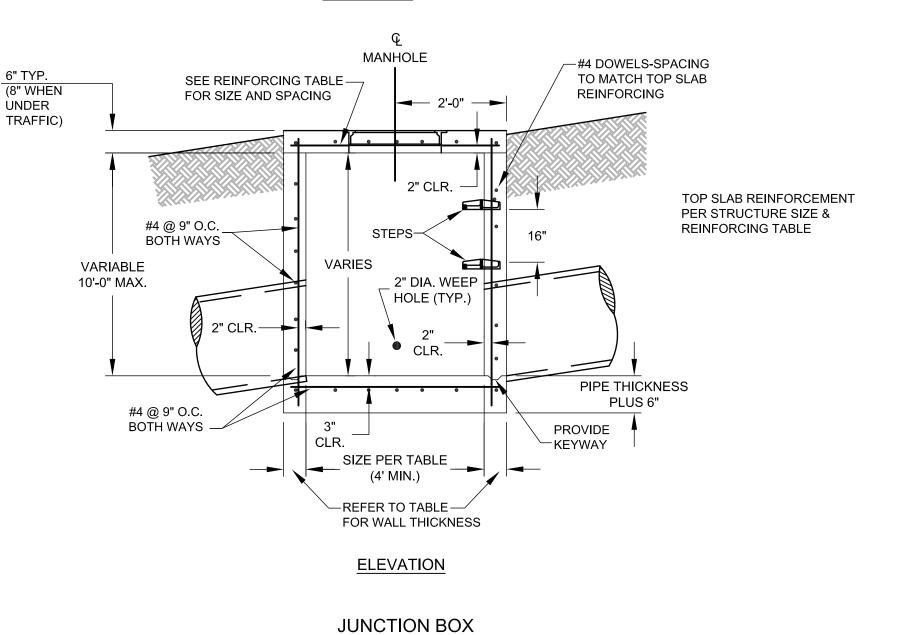

**ORGENSEN**ASSOCIATES



★ CALCULATED POINT

FOUND RAILROAD SPIKE O SET IRON PIN & CAP POWER POLE

△ CENTERLINE MARKER

© SEWER MANHOLE O™II FIRE HYDRANT STREET LIGHT

EXISTING 8" SEWER LINE
EX SS-8 PROPOSED 8" SEWER LINE

EXISTING WATERLINE PROPOSED 8" WATER LINE CENTERLINE STREET

BUILDING SETBACK UTILITY EASEMENT


NEW 5' SIDEWALK UTILITY CROSSING 

EXISTING CONTOUR FINISHED CONTOUR

PROJECT DETAILS

**REVISIONS** 

DRAWN BY: CAZ PROJECT # 2016139 FILE PATH: Z:LSD\2016139\DW( \LSD.DWG

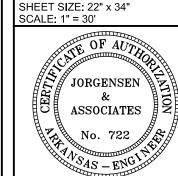




SHEET TITLE **DETAILS** 

SHEET NUMBER

C 5.01

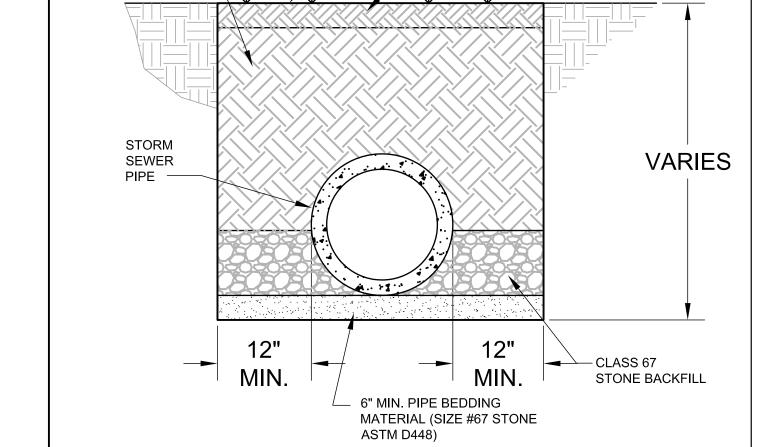

- FINISH GRADE-REVEGETATE

-4" TOPSOIL

ALL TRENCH EXCAVATION SHALL BE IN ACCORDANCE WITH

PROCTOR DENSITY REQUIRED UNDER ALL PAVEMENT

2. FULL DEPTH CLASS 7 ABC BACKFILL COMPACTED TO 95% MODIFIED

OSHA REQUIREMENTS.

COMPACTED SUITABLE

NATIVE MATERIAL

STORM SEWER (RIGID PIPE)