NOTES:

- REVIEW OF THESE PLANS IS LIMITED TO COMPLIANCE WITH CITY CODES AND REGULATIONS. BY REVIEWING AND APPROVING THESE PLANS THE REVIEWER AND THE CITY OF TONTITOWN ASSUME NO RESPONSIBILITY FOR ANY ERRORS OR OMISSIONS IN THE PLANS. THE ADEQUACY OF THE PLANS IS THE SOLE RESPONSIBILITY OF THE DESIGN ENGINEER. THE CITY OF TONTITIONN, HOWEVER, RESERVES THE RIGHT TO REQUIRE CORRECTIVE ACTION IF ANY INADEQUACIES ARE FOUND AFTER THE IMPROVEMENTS ARE CONSTRUCTED
- TO OUR KNOWLEDGE, THERE ARE NO KNOWN GROUND LEASES OR ACCESS AGREEMENTS ON-SITE.
- THERE ARE NO POTENTIALLY DANGEROUS AREAS, OR AREAS SUBJECT TO FLOODING THAT WILL REQUIRE HAZARD MITIGATION.

PAM TRUCKING SCHOOL 294 & 296 W. BANDINI AVE TONTITOWN, ARKANSAS 72762

VARIANCE REQUEST:

OH-SINEL PARKING
153.210(A)4(A)
ON-SITE, EXCEPT AS OTHERWISE SPECIFICALLY PROVIDED, REQUIRED OFF-STREET
PARKING AND LOADING SPACES SHALL BE LOCATED ON THE SAME LOT AS THE
PRINCIPAL USE.

REASON:

STUDENTS AND STAFF WILL PARK AT THE CORPORATE OFFICE AND BE ESCORTED TO THE CLASSROOM BY COLF CART OR OTHER SMALL SITE VEHICLE. DUE TO THE AMOUNT OF SEMI TRUCKS PARKED FOR SERVICING, STACKING 20–30 PERSONAL VEHICLES WOULD INTERFERE WITH THEIR INGRESS/EGRESS AND SERVE AS A DETRIMENT TO THE MECHANIC'S DAY_TO_DAY OPERATIONS

SHEET INDEX No. DATE CLO COMED SHEET 7/11/2023 C2.0 SURVEY SHEET 7/11/2023 C3.0 DEMO AND SWPPP PLAN 1 7/11/2023 7/11/2023 C4.0 SITE PLAN C4.1 PARKING ANALYSIS 7/11/2023 C5.0 GRADING PLAN 1 7/11/2023 CGO LITHITY PLAN 1 7/11/2023 C7.0 DETAILS SHEET 1 7/11/2023 L1.0 LANDSCAPE PLAN 1 7/11/2023 L1.1 LANDSCAPE PLAN 1 7/11/2023 1 7/11/2023 L1.2 LANDSCAPE PLAN

CONSTRUCTION NOTES

- COORDINATE START-UP AND ALL CONSTRUCTION ACTIVITIES WITH THE DEVELOPER'S RESIDENT REPRESENTATIVE.
- CONSTRUCTION METHODS AND MATERIALS NOT SPECIFIED IN THESE PLANS ARE TO MEET OR EXCEED THE SITEWORK SPECIFICATIONS PROVIDED BY EXPEDIENT CIVIL ENGINEERING, PLLC OR AS SPECIFED BY THE DEVELOPER'S RESIDENT REPRESENTATIVE
- ALL CONSTRUCTION WORK AND UTILITY WORK OUTSIDE OF PROPERTY BOUNDARIES SHALL BE PERFORMED IN COOPERATION WITH AND IN ACCORDANCE WITH REQULATIONS OF THE AUTHORITIES CONCERNED.

PUBLIC CONVENENCE AND SAFETY

THE CONTRACTOR SAUL CONDUCT THE WORK IN A MANSES THAT WILL ISSUED, IS A FARCINGABLE, THE LAST OFSTRUCTION TO THE AFFICADO SHALL PROMOE FOR THE CONNENENCE AND SAFETY OF THE AFFICADO SHALL PROMOE FOR THE CONNENENCE AND SAFETY OF THE AFFICADO SHALL PROMOE FOR THE CONSTRUCTION AREA IN AN ADQUART AND SATESFACTORY MANNEY THE CONSTRUCTION AREA IN AN ADQUART AND SATESFACTORY MANNEY THAT CONTRACTORY OF THE STATE ON THE AREA SHALL PROMOED OF THE SAFETY OF

- THE CONSTRUCTION AREA SHALL BE CLEARED, GRUBBED, AND STRIPPED OF TOPSOL AND ORGANIC MATTER FROM ALL AREAS TO ORGANIC MATTER FROM ALL AREAS TO NELDED ON STREET DESCRIPTION OF STREET, AND ALL AREAS MATTER AND ALL AREAS MA
- AREAS TO RECEIVE FILL SHALL BE SCARFFED AND THE TOP 8-INCH DEPTH COMPACTED TO 95% OF THE MAXIMUM DRY DENISTY PER ASTM D1557. ANY UNSUITABLE AREAS SHALL BE UNDERCUT AND REPLACED WITH SUITABLE MATERIAL BEFORE ANY FILL MATERIAL
- C. OFF-SITE FILL MATERIAL (SANDY CLAY, CLAYEY SAND, GRAVELLY OPT-SHIE PILL MATERIAL(SANDY CLAY, CLATEY SAND, GRAVELLY CLAY, OR CLAYY GRAVEL), SHALL HAVE A PLASTICITY NDEX OF 15 OR LESS, A LIQUID LIMIT OF 40 OR LESS, A CBR VALUE GREATER THAN B, AND CONTAIN NO ROOK LARGER THAN B AND SOFT OFF-SHE FILL MATERIAL SHALL BE APPROVED BY THE DEVELOPER'S REPRESENTAINLY PROOR TO BIRRIGHON ON STREAM
- AREAS THAT ARE TO BE CUT TO SUBGRADE LEVELS SHALL BE PROOF ROLLED WITH A PULLY LOADED TANDEN-ALE DUMP TRUCK OR SWIAR A PROVIDE COMPANIE TO DETECT UNSUTIABLE SOLS. CUT AREAS ARE TO BE SCAMPED AND RECOMPACTED TO SESS MANSIAND MOY DON'STY PART A STUD GOBS AND ESSEED BY A GOTECHNICAL ENGINEER PRIOR TO PLACEMENT OF BESTE BY A GOTECHNICAL ENGINEER PRIOR TO PLACEMENT OF
- IN ALL AREAS OF EXCAVATION, IF UNSUITABLE SOILS ARE ENCOUNTERED, A QUALIFIED GEOTECHNICAL ENGINEER SHALL ENCOUNTERED, A QUADIFIED GEDTECHNICAL ENGINEER STALL RECOMMEND TO THE DEVELOPER'S CONSTRUCTION DIVISION ON THE METHODS OF UNDERCUTTING AND REPLACEMENT OF PROPERLY COMPACTED, APPROVED TILL MATERIAL ALL PROOF ROLLING AND UNDERCUTTING SHALL BE PERFORMED DURING A SUFFICIENT DURATION OF DRY MEATHER PERIOD.
- THE CONTRACTOR SHALL BE RESPONSIBLE FOR THE CONTROL OF DUST AND DRIT RISING AND SCATTERING IN THE ARE DURING CONSTRUCTION AND SHALL PROVIDE WATER SEPROBLANG OF OTHER Y. WITH ALL GOVERNING REGULATIONS PERTANNING TO ENMRONMENTAL PROTECTION.
- AN INDEPENDENT TESTING LABORATORY, SELECTED AND PAID BY THE CONTRACTOR, APPROVED BY THE DEVELOPER, SHALL BE RETAINED TO PERFORM CONSTRUCTION TESTING OF THE SUBGRADE FOR COMPLIANCE WITH THE MINIMUM REQUIREMENTS OF SUBGRADE COMPACTION, FOR BASE COURSE AND ASPHALT PANNOL.
- ALL SLOPES ARE TO BE 3:1 OR FLATTER UNLESS OTHERWISE INDICATED. SLOPES STEEPER THAN 3:1, BUT FLATTER THAN 2:1 SHALL BE STABILIZED BY AN APPROVED VEGETATIVE LAYER OR OTHER APPROVED METHODS.
- ALL SLOPES EXCEEDING 2:1 SHALL BE PROTECTED BY RIP—RAP, CONCRETE PANNG, OR OTHER METHODS INDICATED ON THESE PLANS THAT WILL PREVENT EROSON, AND PLACED SUCH THAT THE SURFACE IS FLUSH WITH SURROUNDING GROUND AND SHAPED TO CHANNEL WATER IN DIRECTIONS INDICATED.

- CONTRACTOR SHALL REFER TO THE STORWMATER POLLUTION PREVENTION FLAN AND REPORT FOR STORMMATER QUALITY CONTROL INCLUDING PRACTICES TO PREVENT RESOON ALONG THE EDGE OF PROPERTY. TOE OF FLORE AND ALONG DITCHES MUD AND DEBRIS ARE NOT ALLOWED TO FLOW ONTO ADJACCENT PROPERTIES.
- CONTRACTOR IS TO REMOVE AND DISPOSE OF ALL DEBRIS, RUBBISH AND OTHER MATERIALS RESULTING FROM PREVIOUS AND CURRENT DEMOLITION OPERATIONS.

7. PAVING NOTES:

- ASPHALT CONCRETE SURFACE SHALL BE TYPE 2 PER SECTION 407 AND BASE COURSE WATERIALS SHOULD MEET OR EXCEED THE REQUIREMENTS SPECIFIED IN THE ARKANSA DEPARTMENT OF TRANSPORTATION STANDARD SPECIFICATIONS FOR HIGHWAY CONSTRUCTION, LATEST EDITION.
- AN INDEPENDENT TESTING LABORATORY, SELECTED AND PAID BY THE CONTRACTOR, APPROVED BY THE EDELEDER, SHALL BE, RETAINED TO PERFORM CONSTRUCTION TESTING OF IN-PLACE APPHAL CONCRETE SUPPLY CONCRETED BY A SHALL BE, APPHAL TOWN

8 CONCRETE NOTES:

- CONCRETE PAVING AND STRUCTURES SHOULD CONFORM TO THE ARKANSAS DEPARTMENT OF TRANSPORTATION STANDARD SPECIFICATIONS FOR HIGHWAY CONSTRUCTION, LATEST EDITION.
- AN INDEPENDENT TESTING LABORATORY, SELECTED AND PAID BY THE CONTRACTOR, APPROVED BY THE DEVELOPER, SHALL BE RETAINED TO PERFORM CONSTRUCTION TESTING OF CONCERTE FOR COMPULANCE WITH CONCRETE STRENGTH REQUIREMENTS AS SPECIFIED IN THE CONSTRUCTION SPECIFICATION.
- VERTICAL CONCRETE SURFACES EXPOSED TO THE GENERAL PUBLIC SHALL BE WET-RUBBED TO A SMOOTH FINISH AFTER FORMS HAVE BEEN REMOVED. HORIZONTAL SURFACES SHALL BE BROOMED AS REQUIRED IN THE CONSTRUCTION PROJECT SPECIFICATIONS.
- CONTRACTOR IS TO PROVIDE WEAKENED-PLANE (CONSTRUCTION) JOINTS, SECTIONING CONCRETE INTO AREAS AT 10-FOOT ON CENTERS, MAXIMUM EACH WAY. CONSTRUCT WEAKENED-PLANE JOINTS FOR A DEPTH EQUAL TO AT LEAST 1/4" CONCRETE THICKNESS. CONTRACTOR IS TO FURNISH JOINT FILLERS APPROVED BY THE DEVELOPER'S CONSTRUCTION DIVISION OR

- CONSTRUCTION SHALL NOT START ON ANY PUBLIC UTILITY SYSTEM UNTIL WRITTEN APPROVAL HAS BEEN RECEIVED FROM TONTITOWN WATER AND SEWER, AND THE CONTRACTOR HAS BEEN NOTIFIED BY EXPEDIENT CIVIL ENGINEERING, PLLC.
- CONTRACTOR SHALL NOT OPEN, TURN OFF, INTERFERE WITH, OR ATTACH ANY PIPE OR HOSE TO OR TAP ANY WATER MAN BELONGING TO TONITIONIN WHERE AND SEMEN UNLESS DULY AUTHORIZED TO DO SO BY THE GITS, MAY MOVERSE CONSEQUENCES OF ANY SO-EDULED OR UNSCHEDULED DISAMPLIONS OF SERVICE TO ME POBLIC ARE TO BE THE LIBBUILT OF THE CONTRACTOR EXPENDENT DONE, ENGINEERING, PLIC AND THE DEVELOPER ARE TO BE HELD HARMLESS.
- DISINFECTION AND PRESSURE TESTING OF WATER LINES SHALL BE PERFORMED AND PAID FOR BY THE CONTRACTOR LINES SUPERMISION OF MERCHAND FOR THE OF EXPEDITION COME, ENGINEERING, PLIC. CONTRACTOR SHALL NOTIFY EXPEDIENT CIMI, ENGINEERING, PLIC AT LEAST ONE WEEK IN ADVANCE, PRIOR TO ANY TESTING.
- ALL WATER AND SCHEM MANIS THAT ARE TO BE PUBLIC LINES SHALL BE CONSTRUCTED IN ACCORDANCE WITH TOWNTOWN WATER AND SCHEM STANDARD SPECIFICATIONS DATE OF 0/25/2018 AND THE ARRANASS STATE HEALTH OFFARTMENT STANDARD SPECIFICATIONS, AND SHALL BE SECURED BY THE UTILITY MESPECIFICATIONS, AND SHALL BE SECURED BY THE UTILITY MESPECIFICATION AS TOWNERS OF CONTROL OF THE STANDARD SPECIFICATION OF THE STAN

10. BLASTING AND EXPLOSIVE MATERIALS:

- THE CONTRACTOR IS SUBJECT TO ALL FEDERAL, STATE AND LOCAL REGULATIONS GOVERNING THE USE AND STORAGE OF EXPLOSIVE MATERIALS AND IS RESPONSIBLE FOR OBTAINING ALL REQUIRED PERMITS AND LICENSES.
- EXPEDIENT CIVIL ENGNEERING, PLLC ACCEPTS NO RESPONSIBILITY OR LIABILITY PERTAINING TO STORAGE, USE, MCTHODS, MROCEDMERS, SAFETY PERFORMENT OF STORAGE AND ADMINISTRATION OF STORAGE AND ADMINISTRATION OF STORAGE AND THE ASSOCIATES HARMLESS WITH REGARD TO BLASTING AND EXPENSIVE MATERIALS.





RESOURCE LIST

BLACK HILLS ENERGY
MR. JOSH KNIGHT
JOSHUA KNIGHTØBLACKHILLSCORP.COM

COX COMMUNICATIONS
MR. CHAD HODGE & TIMOTHY GOSS

OZARKS ELECTRIC COOPERATIVE

TONTITOWN WATER UTILITIES

UTILITY LOCATIONS ARKANSAS

MR. LAYNE RHODES

TONTITOWN PLANNING

ADDRESS

FAYETTEVILLE, ARKANSAS 72703

4901 S. 48TH STREET SPRINGDALE, ARKANSAS 72762

PO BOX 305 TONTITOWN, AR 72770

400 JEAN MARY AVE SPRINGDALE, AR 72762

1301 FEDERAL WAY

1133 F HAROLD ST



TELEPHONE

(479) 414-5567

(479) 333-7005

(479) 571-6609

(479) 435-8080

TIM(479) 651-5563 TIMCTHY, COSSIDOOX, COM

(479) 521-2900

(479) 361-2996

1-800-482-8998

CERTIFICATE OF PRELIMINARY ENGINEERING ACCURACY

HEREBY CERTIFY THAT THIS PLAN CORRECT
REPRESENTS A PLAN PREPARED UNDER MY DRICCION AND ENDNECTING REQUIREMEN
OF THE TONITION'S SUBJECTION.

AND REPORT OF THE CONTROL OF THE CONTROL OF THE CONTROL OF THE CONTROL OF THE CO ŝ

GIST	ERE	D ENGINEE	R	
			DEC-PYDATION	110

CERTIFICATE OF CHINESSAR WERE SO THE REAL ESTATE SHOWN AND DESCRIBED WE THE UNDERSONED. WHIRE SO, THE REAL ESTATE SHOWN AND DESCRIBED AND CHINESSAND OF THE STATE OF THE STATE

DATE OF EXECUTION:	
SIGNED :	
NAME & ADDRESS:	
SOURCE OF TITLE: D.R PAGE	

CERTIFICATE OF SURVEYING ACCURACY

REPRESENTS A BOUNDARY SURVEY MAD BEY ME AND BOUNDARY MARKERS AND LOT CORNERS SHOWN HERCON ACTUALLY EXIST AND THAT LOCATION, TYPE AND MATERIA. ARE CORRECTLY SHOWN AND ALL MINIMAN REQUIREMENTS OF THE ARKANSAS MINIMAN STRANDARDS FOR LAND SURVEYORS HAVE EETH MET.

DATE OF EXECUTION:	
SIGNED: REGISTERED LAND SURVEYOR	
STATE OF ARKANSAS REGISTRATION NO.	

PURSUANT TO THE CITY OF TONTITOWN SUBDIMISION REGULATIONS AND ALL OTHER PURSUANT TO THE CITY OF TONTTOWN SUBDIMISION REGULATIONS AND ALL OTHER CONDITIONS AND APPROXIMAS MANNE BEEN COMPLETED, THIS DOCUMENT IS MALE OF THE CONDITION AND APPROXIMAS MANNE BEEN COMPLETED, THIS DOCUMENT OF THE SAID REGULATIONS.

1. BELLATION OF THE WAITE OR SIZERY SERVICE.

1. BELLATION OF THE WAITE OR SIZERY SERVICE.

3. MIRPOWALMENTS TO ANY PETCHED CITY STREETS OR COUNTY ROADS.

4. APPROVILE FROM THE ARMANISM DEPARTMENT OF HEALTH.

1. DECEMBER OF THE SAID OF THE

DATE OF EXECUTION: ___ SIGNED: CHAIRMAN, TONTITOWN PLANNING COMMISSION MAYOR CITY OF TONTITOWN

CLERK-TREASURER , CITY OF TONTITOWN



Know what's below. Callbefore you dig.

ARKANSAS REGISTERED

No.11411

- Se

SCHOOL

TRUCKING

AM

342


Ö

0

400 JEAN MARY AVE SPRINGDALE,

CJL	
CHECKED BY: JEI	
DATE 6/20/2023	
JOB NUMBER 23-1014	
SHEET NAME	
COVER	

SHEET

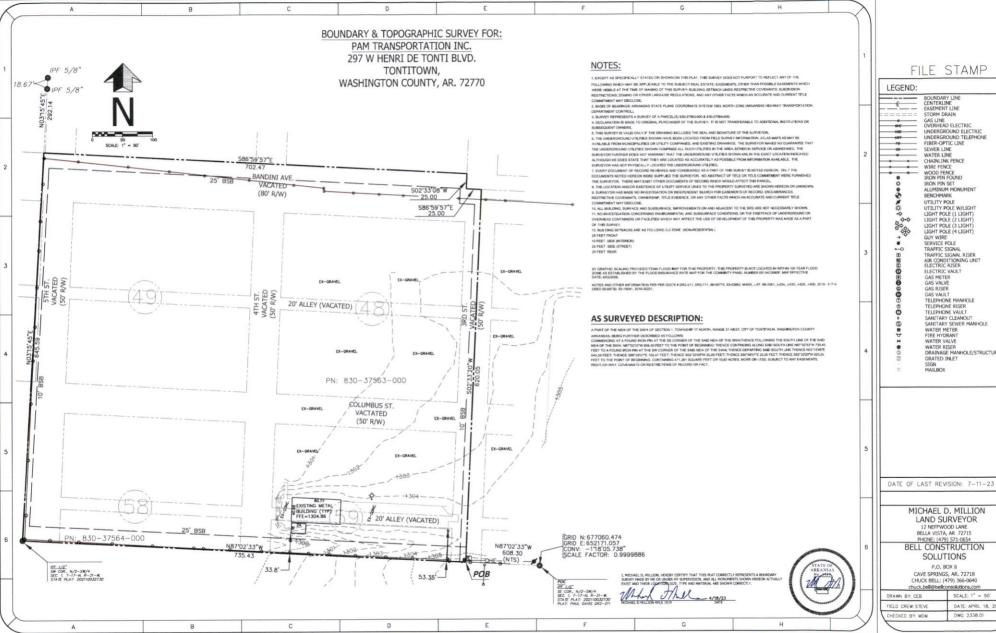



LEGEND:	
	BOUNDARY LINE
	CENTERLINE
	EASEMENT LINE
======	STORM DRAIN
•	GAS LINE
- OE	OVERHEAD ELECTRIC
va	UNDERGROUND ELECTRIC
	UNDERGROUND TELEPHONE
70	FIBER-OPTIC LINE SEWER LINE
- 60	
	WATER LINE
•	CHAINLINK FENCE
	WIRE FENCE WOOD FENCE
	IRON PIN FOUND
	IRON PIN SET
	ALUMINUM MONUMENT
<u>a</u>	BENCHMARK
2	UTILITY POLE
4	UTILITY POLE W/LIGHT
345	LIGHT POLE (1 LIGHT)
Ant.	LIGHT POLE (2 LIGHT)
22	LIGHT POLE (2 LIGHT)
****	LIGHT POLE (4 LIGHT)
3000	GUY WIRE
	SERVICE POLE
0	TRAFFIC SIGNAL
III)	TRAFFIC SIGNAL RISER
RI .	AIR CONDITIONING UNIT
63 ID	ELECTRIC RISER
0	ELECTRIC VAULT
•	GAS METER
6≡0 00000000000000000000000000000000000	GAS VALVE
0	GAS RISER
©	GAS VAULT
Φ	TELEPHONE MANHOLE
Φ	TELEPHONE RISER
Φ	TELEPHONE VAULT
6	SANITARY CLEANOUT
(2)	SANITARY SEWER MANHOLE
	WATER METER
U	FIRE HYDRANT
м	WATER VALVE
	WATER RISER
0	DRAINAGE MANHOLE/STRUCTURE
₩	GRATED INLET

LAND SURVEYOR

CAVE SPRINGS, AR. 72718 CHUCK BELL: (479) 366-0640

DRAWN BY: CEB	SCALE: 1" = 50'
FIELD CREW: STEVE	DATE: APRIL 18, 2023
CHECKED BY: MDM	DWG: 2338.01

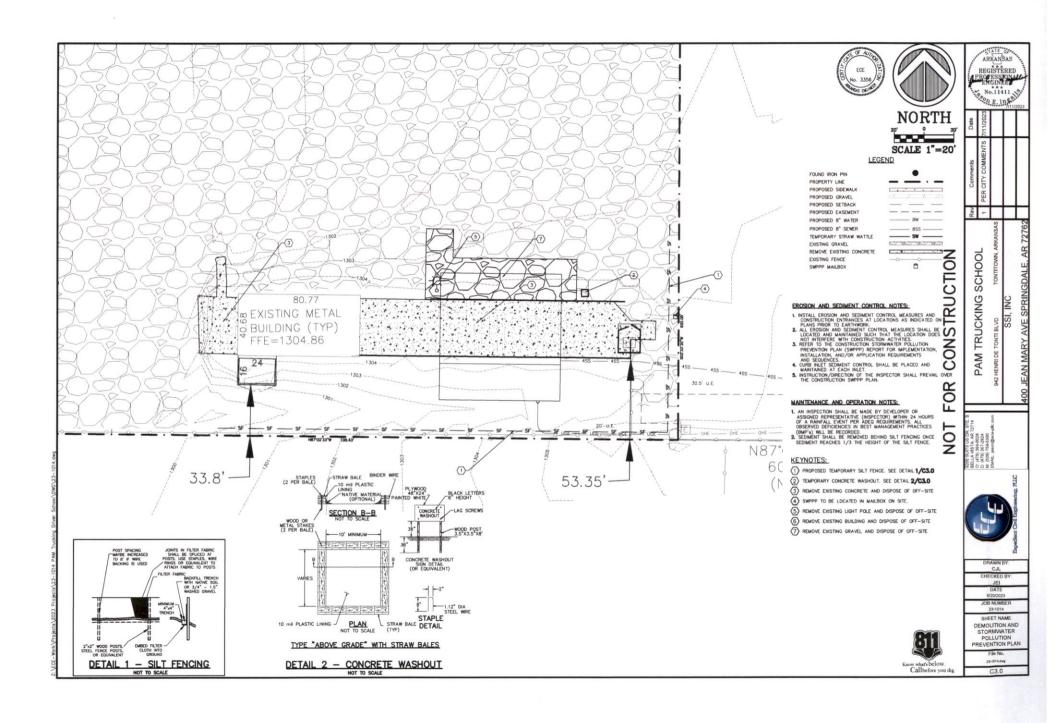

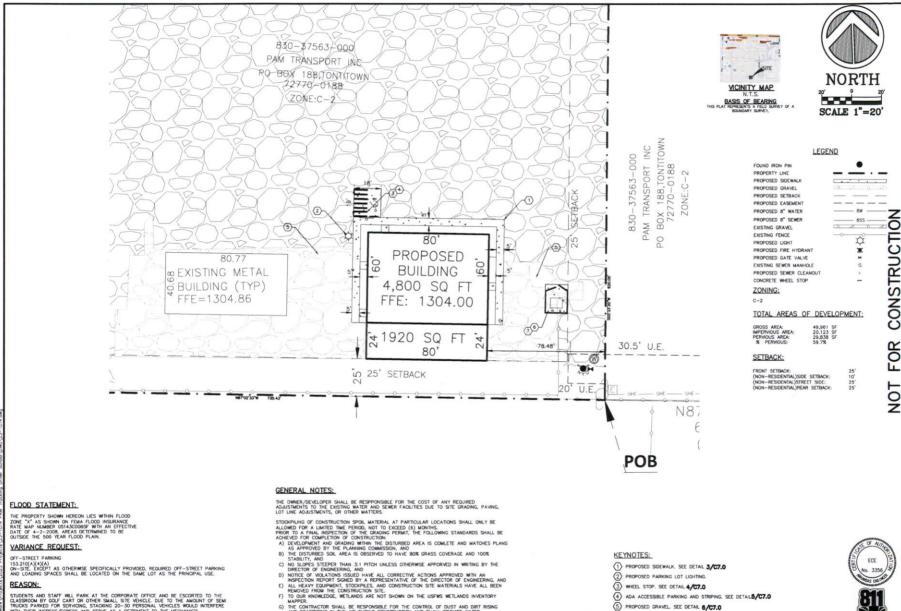

153.210(A)(4)(A)
ON-SITE, EXCEPT AS OTHERWISE SPECIFICALLY PROVIDED, REQUIRED OFF-STREET PARKING AND LOZDING SPACES SHALL BE LOCATED ON THE SAME LOT AS THE PRINCIPAL USE.

STUDENTS AND STAFF WILL PARK AT THE CORPORATE OFFICE AND BE ESCORTED TO THE CLASSROOM BY GOLF CART OR OTHER SMALL STE VEHICLE DUE TO THE ANOUNT OF SEMITRUCKS PARKED FOR SERVICING, STACKING 20-30 PERSONAL VEHICLES WOULD INTERFERE WITH THEIR MIGRESS/EDRESS AND SERVE AS A DETRIBENT TO THE MECHANIC'S DAY-TO-DAY OFFERATIONS.

- MAPPER.

 G) THE CONTRACTOR SHALL BE RESPONSIBLE FOR THE CONTROL OF DUST AND DIRT RISING AND SCATTERING IN THE AIR DURING CONSTRUCTION AND SHALL PROVIDE MATER. SPRINKLING OR OTHER SUTFALE METHODS OF CONTROL. THE CONTRACTOR SHALL COMPLY WITH ALL COVERNION REGULATIONS PERTAINING TO ENVIRONMENTAL PROTECTION. THERE MILL BE ZERO TOLERANCE, FOR NONCOMPLIANCE PER TONTIOTION PROMERENGE OF PERTAINING.

- (1) PROPOSED SIDEWALK. SEE DETAIL 3/C7.0
- 2 PROPOSED PARKING LOT LIGHTING.
- 3 WHEEL STOP. SEE DETAIL 4/C7.0
- 4 ADA ACCESSIBLE PARKING AND STRIPING. SEE DETAIL5/C7.0
- 5 PROPOSED GRAVEL SEE DETAIL 6/C7.0
- 6 TRASH ENCLOSURE. SEE ARCHITECT PLANS
- 7 HEAVY CONCRETE SECTION SEE DETAIL 7/C7.0





DRAWN BY	٦
CJL	
CHECKED BY:	٦
JEI	4
DATE	1
6/20/2023	4
JOB NUMBER	١
23-1014	4
SHEET NAME	1
	1
SITE	١
PLAN	ı

ARKANSAS REGISTERED

No.11411

SCHOOL

PAM TRUCKING

SPRINGDALE.

23-1014.des